PROPOSED NEW RESIDENCE

Lot 6507, BONNIEBROOK ROAD, BONNIEBROOK, VIC 3335

FOR CONSTRUCTION - ARCHITECTURAL DOCUMENT





G E N E R A L

ALL WORKS TO BE CARRIED OUT IN ACCORDANCE WITH BUILDING ACT 1993, BUILDING REGULATIONS 2018, NCC 2022 AND RELEVANT STANDARDS.

THE BUILDER AND SUBCONTRACTOR TO VERIFY ALL EXISTING CONDITIONS, RELEVANT LEVELS AND DIMENSIONS ON-SITE PRIOR TO COMMENCING ANY BUILDING WORKS OR PREFABRICATION.

ARCHITECTURAL DRAWING SHALL BE READ IN CONJUNCTION WITH ANY STRUCTURAL ENGINEERING COMPUTATIONS OR STRUCTURAL DRAWINGS.

FIGURED DIMENSIONS TAKE PRECEDENCE OVER SCALED DRAWINGS.

BUILDER TO ADHERE TO ALL BUILDING PERMIT CONDITIONS AND PLANNING PERMIT CONDITIONS. PLEASE CONSULT ARCHITECT IF THERE ARE ANY DISCREPANCIES.

ALL MATERIALS & METHODS OF CONSTRUCTION SHALL COMPLY WITH RELEVANT S.A.A CODES, NCC 2022 AND LOCAL COUNCIL BY-LAWS.

DO NOT SCALE DRAWINGS

PROVIDE IMPERVIOUS FLOOR & WALL FINISHES TO ALL WET AREAS IN ACCORDANCE WITH NCC 2022 PART 10.2.1.

CONNECT STORMWATER AND SULLAGE DRAINS INTO LEGAL POINTS OF DISCHARGE, ALL DRAINS SHALL COMPLY WITH LOCAL AUTHORITIES REGULATIONS AND AS3500.3-2018.

PROVIDE 90MM DIA. AGRICULTURAL DRAINS TO THE BASE OF ALL EXCAVATIONS BANKS AND RETAINING WALLS. CONNECT TO STORMWATER VIA SILT PIT.

SMOKE ALARMS TO COMPLY WITH AS3786-2014.
SMOKE ALARMS TO BE INSTALLED IN ACCORDANCE WITH NCC 2022. SMOKE ALARMS MUST BE INTERCONNECTED DIRECTLY TO MAINS POWERS.

REFER TO SOIL REPORT FOR SOIL CLASSIFICATIONS AND FOUNDING DEPTHS. ALL EXPOSED STEEL TO BE HOT DIPPED GALVANISED.

PROVIDE MECHANICAL VENTILATION IN ACCORDANCE WITH NCC 2022 AS REQUIRED. ALL EXHAUST FANS ARE TO DISCHARGE TO THE EXTERIOR OF THE BUILDING.

FOOTINGS

REINFORCED CONCRETE STRIP FOOTINGS & PAD FOOTINGS TO ENGINEERS DESIGN. FOOTING CONSTRUCTION TO COMPLY WITH NCC 2022.

WALL FRAMING

TIMBER WALL FRAMING IS TO COMPLY WITH AS1684.2-2010 "RESIDENTIAL TIMBER FRAMED CONSTRUCTION NON-CYCLONIC AREAS" AND OR AS1684.3-2010 "RESIDENTIAL TIMBER FRAMED CONSTRUCTION CYCLONIC AREAS" AND WITH SUPPLEMENTARY TABLES.

PROVIDE DOUBLE STUD, STUMP & PAD UNDER ALL LOAD POINTS.

ALL STRUCTURAL STEEL IS TO COMPLY WITH AS4100-1998 (R2016).

WALL TIE DOWNS ARE TO BE INSTALLED IN ACCORDANCE WITH NCC 2022 PART 7.3. THE TYPES OF WALL TIES DOWNS MAY BE INCLUSIVE OF METAL STRAPS, BOLTS, SCREWS. COACH SCREWS AND FRAMING ANCHORS.

ALL EXTERNAL STEEL LINTELS ARE TO BE HOT DIPPED GALVANIZED AND THE WALL TIES PROVIDED ARE TO BE STAINLESS STEEL (PART 6.3 OF THE NCC 2022).

MASONRY

ALL MASONARY WORK IS TO COMPLY WITH AS4773-SET:2015 AND NCC 2022.

CONCRETE STRUCTURES

ALL CONCRETE STRUCTURES ARE TO COMPLY WITH AS 3600-2018 AND NCC 2022.

INSULATION

REFER TO ENERGY REPORT FOR INSULATION REQUIREMENTS IN WALLS AND CEILINGS

PROVIDE SOUND-DAMPENING AND SARKING TO METAL ROOFS: 50 MM THICK FIBERGLASS BLANKETS. SISILATION FLAMMABILITY INDEX NO GREATER THAN 5. SUPPLY AND INSTALL SISILATION

WINDOWS/GLAZING

ALL WINDOWS SHALL CONFORM TO AS2047-2014 AND ALL GLAZING TO AS1288 -2021 & NCC 2022 PART 8.1.

GLAZING WITHIN 2000MM OF THE F.F.L IN BATHROOMS OR ENSUITES IS TO BE GRADE A SAFETY GLASS.

ALL SIZES SHOWN ARE NOMINAL AND SHOULD BE COMPARED TO MANUFACTURERS STANDARD SCHEDULE BEFORE CONSTRUCTION COMMENCES. NON-STANDARD WINDOWS TO HAVE SIZES CHECKED ON SITE PRIOR TO MANUFACTURING. REFER TO ELEVATIONS FOR SASH ARRANGEMENT. ALL WINDOW SIZES & CLEARANCES TO BE CHECKED ON SITE PRIOR TO MANUFACTURING.

GRADE A SAFETY GLASS IS REQUIRED TO ALL GLAZING IN BATHROOMS, ENSUITES, SPA ROOMS, SHOWER DOORS, SHOWER SCREENS, BATH ENCLOSURES, AND ASSOCIATED WINDOWS, WHERE THE LOWEST SIGHT LINE IS LESS THAN 2.0 M ABOVE THE HIGHEST ABUTTING FINISHED LEVEL OF THE FLOOR, BOTTOM OF THE BATH, OR SHOWER BASE

PLEASE NOTE THAT WINDOWS CAPABLE OF BEING MISTAKEN FOR A DOORWAY OR OPENING AND GREATER THEN 500MM IN WIDTH, 1M IN HEIGHT AND WITHIN 700MM OF THE FINISHED FLOOR ARE TO BE PROVIDED WITH A MID-HEIGHT MOTIF WITHIN ITS PANEL IN ACCORDANCE WITH NCC 2022.

TIMBER FRAMING

TIMBER WALL FRAMING IS TO COMPLY WITH AS1684.2-2010 "RESIDENTIAL TIMBER FRAMED CONSTRUCTION NON-CYCLONIC AREAS" AND OR AS1684.3-2010 "RESIDENTIAL TIMBER FRAMED CONSTRUCTION CYCLONIC AREAS" AND WITH SUPPLEMENTARY TABLES. PROVIDE DOUBLE STUD, STUMP & PAD UNDER ALL LOAD POINTS

WALL BRACING LAYOUT IN CONJUNCTION WITH THE WALL TIE DOWN DETAILS (TOP PLATES TO STUDS) ARE TO COMPLY WITH AS1684-2021. WALL TIE DOWNS (TOP PLATES TO STUDS) ARE TO BE INSTALLED AT MINIMUM 1800 CTRS (EVERY 4TH STUD). THE TYPES OF WALL TIES DOWNS MAY BE INCLUSIVE OF METAL STRAPS, BOLTS, SCREWS, COACH SCREWS AND FRAMING ANCHORS. WALL BRACING NO GREATER THEN 9M APART.

TRUSS/POSISTRUTT

PROVIDE AN ELECTRONIC COPY OF THE ROOF TRUSS/POSISTRUTT MANUFACTURER'S DESIGN AND LAYOUT OF THE BEAMS ARE TO BE SUBMITTED PRIOR TO THE FRAME INSPECTION BEING CARRIED OUT. NOTE: THE FRAME INSPECTION WILL NOT BE CARRIED OUT INTIL SLICH TIME

THAT COPY OF FULL TRUSS COMPUTATIONS AND LAYOUT PLANS ARE PROVIDED AND APPROVED BY THE RELEVANT BUILDING SURVEYOR. NOTE DISCS WILL NOT BE ACCEPTED.

CONCRETE:

ALL CONCRETE MATERIAL AND WORKMANSHIP SHALL BE IN ACCORDANCE AS3600-2018 CONCRETE STRUCTURES CODE.

ALL CONCRETE SHALL BE CURED IN ACCORDANCE WITH AS3600-2018. ALL REINFORCEMENT TO BE LAID AND LAPPED TO MANUFACTURERS SPECIFICATIONS ON APPROVED BAR CHAIRS.

CONCRETE STRENGTH 25MPA (MIN) AT 28 DAYS.

ALL WORKS TO BE IN ACCORDANCE WITH AS2870-2011 "RESIDENTIAL SLABS AND FOOTING CONSTRUCTION"

OWNERS MUST RECOGNIZE THEIR RESPONSIBILITIES NOTED IN
AS 2870-2011 AND MORE DETAIL IN C.S.I.R.O PUBLICATION "GUIDE TO
HOMEOWNERS ON FOUNDATION MAINTENANCE AND PERFORMANCE."

ALL EXCAVATIONS SHOULD BE CAREFULLY INSPECTED BY A COMPETENT PERSON AND THIS OFFICE CONTACTED IMMEDIATELY IF CONDITIONS OTHER THAN THOSE DESCRIBED IN THE SOIL REPORT ARE ENCOUNTERED.

CONCRETE SLAB

REINFORCED CONCRETE FLOOR SLAB TO ENGINEERS DESIGN.
CONSTRUCTION OF CONCRETE SLAB TO COMPLY WITH NCC 2022 & AS2870.

FLOORING

REINFORCED CONCRETE FLOOR SLAB TO ENGINEERS DESIGN. CONSTRUCTION OF CONCRETE SLAB TO COMPLY WITH NCC 2022 & AS2870.

SUB-FLOOF

SUB-FLOOR VENTILATION IS TO BE INSTALLED AT A MINIMUM OF EVERY 6000MM² PER METER RUN OF WALL IN COMPLIANCE WITH NCC 2022. THE SUB-FLOOR ACCESS DOOR IS TO BE LOCATED IN A READILY ACCESSIBLE POSITION.

ROOFIN

TIMBER ROOF FRAMING IS TO COMPLY WITH AS1684.2-2021 "RESIDENTIAL TIMBER FRAMED CONSTRUCTION NON-CYCLONIC AREAS" AND OR AS1684.3-2021 "RESIDENTIAL TIMBER FRAMED CONSTRUCTION CYCLONIC AREAS" AND WITH SUPPLEMENTARY TABLES.

TIMBER ROOF TRUSSES AT 900MM CTS TO MANUFACTURERS SPECIFICATIONS PROVIDE GALV. IRON CROSS BRACING OVER ROOF TRUSSES EXPOSED COLORBOND GUTTERS AND FASCIAS, INSTALLED PER NCC. 2022.

ALL ROOF STORMWATER DRAINAGE SHALL COMPLY WITH AS3500.3-2018 ENSURE ALL SARKING BENEITH TILED ROOFS IS PROVIDED IN ACCORDANCE WITH PART 7.3.OF THE NCC 2022, AND HAS A FLAMMABILITY INDEX OF NOT MORE THEN 5.

STEEL PROTECTION

ALL EXTERNAL STEEL LINTELS ARE TO BE HOT DIPPED GALVANIZED AND THE WALL TIES PROVIDED ARE TO BE STAINLESS STEEL, PLEASE CONFIRM THIS ON PLAN. (PART 6.3 OF THE NCC 2022).

STAIRS

- STAIRS, STEPS & LANDINGS TO COMPLY WITH NCC. 2022.
- RISERS 115MM MIN, 190MM MAX.
- GOINGS 240MM MIN 355MM MAX.
- HANDRAIL TO BE 865MM ABOVE NOSING OF TREAD.
- 1000MM HIGH BALUSTRADING & 865 ABOVE STAIR NOSING
- 125MM MAXIMUM BETWEEN BALUSTERS
- PROVIDE 2000MM MIN HEAD ROOM CLEARANCE FROM TREAD NOSING
- MAX 3 RISERS OR 570MM WITHOUT A LANDING TO DOOR OPENING
- SLOPE RELATIONSHIP 2R + G 550MIN 700MAXTHE MAXIMUM GAP BETWEEN RISERS IN OPEN STAIRS IS 125MM WHERE THE STAIR IS IN EXCESS OF 1000MM ABOVE THE ADJACENT ELOOR LEVEL
- ALL TREADS ARE TO HAVE A NON-SLIP FINISH OR A NON-SLIP STRIP IS TO BE PROVIDED TO THE NOSING.

HANDRAILS

A HANDRAIL IS TO BE PROVIDED ALONG AT LEAST ONE SIDE OF THE INTERNAL STAIRS.

THE TOP SURFACE OF THE HANDRAIL IS TO BE NOT LESS THAN 865MM VERTICALLY ABOVE THE NOSINGS OF THE STAIR TREADS AND HAVE NO OBSTRUCTION ON OR ABOVE

DRAINAGE

ALL EXISTING UNDERGROUND SERVICES ARE TO BE LOCATED PRIOR TO EXCAVATION FOR NEW PIPES LINES AND NO EXISTING SERVICE SHALL BE DISCONNECTED OR DISTURBED WITHOUT APPROVAL FROM ENGINEER.

STORM-WATER DRAINS SHALL BE 100MM DIAMETER AT A GRADE OF 1:100 UNLESS NOTED OTHERWISE.

ALL PIPE JUNCTIONS SHALL BE WITH A 45 DEGREE JOINT.

ALL U-PVC PIPES SHALL CONFORM TO AS1260-2009 "PVC-U PIPES AND FITTINGS FOR DRAIN, WASTE AND VENT APPLICATION" $\,$

THE SITE SHOULD BE DRAINED SO THAT THE WATER CANNOT POND AGAINST OR NEAR THE BUILDING. THE GROUND IMMEDIATELY ADJACENT TO THE BUILDING SHOULD BE GRADED TO FALL 50MM OVER THE FIRST METER. WHERE THIS IS IMPRACTICABLE (I.E. SEVERAL SLOPING SITES) USE AGGIE DRAINS ADJACENT TO THE FOOTINGS WHERE THE GROUND FALLS TOWARDS THE BUILDING.

SURFACE DRAINAGE

THE GROUND BENEATH SUSPENDED FLOORS MUST BE GRADED SO THAT THE AREA BENEATH THE BUILDING IS ABOVE THE ADJACENT EXTERNAL FINISHED GROUND LEVEL AND SURFACE WATER IS PREVENTED FROM PONDING UNDER THE BUILDING.

TERMITE TREATMENT

SITE TO BE TREATED AGAINST SUBTERRANEAN TERMITES IN ACCORDANCE WITH AS3660.1 TO LOCAL AUTHORITIES SATISFACTION AS3660.1 TERMITE MANAGEMENT REQUIRES A MINIMUM OF 400MM CLEARANCE FROM GROUND LEVEL TO THE UNDERSIDE OF THE BEARER (THIS CAN BE REDUCED TO 200MM ON A SLOPING SITE)

MECHANICAL VENTS

ANY CONTAMINATED AIR FROM A SANITARY COMPARTMENT OR BATHROOM MUST A.EXHAUST DIRECTLY TO OUTSIDE THE BUILDING BY WAY OF DUCTS; OR B.EXHAUST INTO THE ROOF SPACE PROVIDED-(I) IT IS ADEQUATELY VENTILATED THAT COMPLIES WITH NCC 2022 (II) THE ROOF IS CLAD IN ROOFING TILES WITHOUT SARKING OR SIMILAR MATERIALS WHICH WOULD PREVENT VENTING THROUGH GAPS BETWEEN TILES

EXHAUST FAN DISCHARGE RATES TO BE
A. SANTITARY COMPARTMENTS AND BATHROOMS - 25I/S
B. kITCHEN AND LAUNDRY - 40I/S

DOWNPIPES

100X50 OR 90MM DIAMETER DOWNPIPES ARE REQUIRED TO BE PROVIDED AT 12 METER MAXIMUM SPACING.

MINIMUM BOX GUTTER DIMENSIONS SHALL BE 200MM WIDE X 100MM DEEP.

ALL DOWNPIPES ARE TO BE CONNECTED TO THE APPROVED POINT OF DISCHARGE TO THE SATISFACTION OF THE RELEVANT BUILDING SURVEYOR.

WASTE PIPE LAGGING

PROVIDE SOUND ABSORBING INSULATION AROUND ALL WASTE PIPES FROM FIRST FLOOR WET AREAS (BATHROOMS/ENSUITES/LAUNDRY)

TOILET DOORS

TOILET DOORS ARE TO BE FITTED WITH REMOVABLE HINGES,
OR ARE TO SWING OUT, OR BE SLIDING WHERE THE HINGE IS WITHIN 1200MM OF
THE
PAN.

EEPHOLES

OPEN PERPENDICULAR JOINTS 'WEEPHOLES' MUST BE PROVIDED ABOVE ALL
OPENINGS OVER 1200MM WIDE AND 1200MM CTRS IMMEDIATELY ABOVE THE DPC.

WET AREAS

TO COMPLY WITH NCC 2022 10.2.

PLIABLE BUILDING MEMBRANE

PLIABLE BUILDING MEMBRANE TO BE PROVIDED IN ACCORANCE WITH NCC 2022 AND TO BE LOCATED ON THE EXTERIOR SIDE OF THE PRIMARY INSULATION LAYER OF WALL ASSEMBLIES THAT FORM THE EXTERNAL ENVELOPE.

ALL PLIABLE BUILDING MEMBRANES SHALL COMPLY WITH AS4200.1 AND INSTALLED IN ACCORDANCE WITH AS4200.2.

BUSHFIRE ATTACK LEVEL

 $\label{local_constraint} \mbox{CLASSIFICATION} = \mbox{TO BE DETERMINED BY REGISTERED BUILDING SURVEYOR IF REQUIRED.}$

FLASHING

ALL FLASHING TO BE INSTALLED IN ACCORDANCE WITH AS/NZS 2904-1995 AND COMPLY WITH THE BCA.

ARTICULATION JOINTS

ARTICULATION JOINTS ARE TO COMPLY WITH PART 5.2.5 OF THE NCC 2022 (MINIMUM EVERY 5M CENTRES).

LOGS FOR PILES OR PIERS

UPON COMPLETION, PROVIDE A COMPLETE COPY OF THE RECORDS FOR THE PILE/PIER DRIVING OPERATIONS.

LIGHTING

MAINS ELECTRICITY SUPPLY, TELSTRA AND OTHERS TO BE LOCATED IN ACCORDANCE WITH THE RESPONSIBLE AUTHORITIES REQUIREMENTS. ALL ELECTRICAL SWITCHES AND

POINTS SHALL BE INSTALLED IN ACCORDANCE WITH AS3000-2018, NCC AND ELECTRICAL AUTHORITIES REQUIREMENTS. PROVIDE SAFETY SWITCHES (RCD) TO ALL LIGHTING AND POWER POINT CIRCUITS.

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NO:	DESCRIPTION	DATE
1	PRELIMINARY	14/11/2024
2	PRELIMINARY - R2	25/02/2025
3	PRELIMINARY - R3	27/02/2025
4	DEVELOPER APPROVAL	28/03/2025
5	DEVELOPER APPROVAL - R2	21/04/2025
6	DEVELOPER APPROVAL - R3	02/05/2025
7	FOR CONSTRUCTION	17/05/2025

CLIENT SIGN OFF:

I/WE CONFIRM THAT THESE DRAWINGS ACCORD WITH OUR REQUIREMENTS AND AUTHORISE THEIR USE FOR NEXT STAGE PURPOSES.

SIGNED.....DATE.....

PROJECT:

PROPOSED NEW RESIDENCE

ADDRESS: Lot 6507, BONNIEBROOK ROAD, BONNIEBROOK, VIC 3335

> Details: Lawrence Gilbert Makoona & Marie Tracy Lo Shun Shing

DRAWING:

JOB NUMBER:

08206

GENERAL NOTES & DRAWING SCHEDULE SCALE:

DATE: 17/05/2025 DRAWING NUMBER: A0002

UEOKED DV.

CHECKED BY: AR DRAWN BY: RS



SITE PLAN NOTES

- STORM WATER AND SEWER TO BE CONNECTED TO LEGAL POINT OF DISCHARGE IN ACCORDANCE WITH LOCAL AUTHORITIES REQUIREMENTS DOWNPIPES (DP) TO APPROX. LOCATION MAX 12M CRTS. CONNECTED TO S/WATER SYS. IN ACCORDANCE WITH LOCAL COUNCIL REQUIREMENTS. ALL S/WATER DRAINS THAT PASS UNDER CONC. SLABS AND TRAFFICABLE AREAS TO BE LAID IN HEAVY DUTY SEWER PIPE.
- BUILDER TO PROVIDE AGI DRAIN TO BASE OF BATTERS / RETAINING WALLS & WHERE EVER DEEMED NECESSARY. PROVIDE SILT PITS TO BASE OF BATTER, CONNECTED TO S/WATER SYSTEM. TYPICAL
- PROVIDE CUT OFF (AGI) DRAIN AS REQUIRED TO BASE OF ANY EXCAVATION AND CONNECT INTO STORM WATER VIA SILT PITS.
- PROPERTY LAYOUT IS BASED UPON INFORMATION PROVIDED BY BUILDER OR OWNER AND THEREFORE ALL DIMENSIONS, OFFSETS AND DETAILS MUST BE VERIFIED ONSITE PRIOR TO COMMENCING ANY SETOUTS AND OR BUILDING WORKS.
- LEVELS MUST BE VERIFIED ON SITE TO DETERMINE DEPTH OF EXCAVATIONS AND AFFECTED WALL HEIGHTS PRIOR TO COMMENCING ANY BUILDING WORK.
- PROVIDE TERMITE PROTECTION TREATMENT TO SITE IN ACCORDANCE WITH AS3660.1 AS PER LOCAL AUTHORITY PROPERTY ASSESSMENT.

BUILDER NOTES

- BUILDER AND CONTRACTORS ARE TO CHECK AND VERIFY ALL PLANS AND DRAWINGS PRIOR TO COMMENCING CONSTRUCTION. ANY DISCREPANCIES ON THE DRAWINGS MUST BE REPORTED TO THE RELEVANT BUILDING DESIGNER IMMEDIATELY PRIOR TO COMMENCING CONSTRUCTION
- BUILDER TO ENSURE NO PART OF CONSTRUCTION **ENCROACHES TITLE BOUNDARIES OR EASEMENT LINES**
- REFER TO ENG'S DETAILS AND SOIL REPORT FOR REQUIREMENTS IN FOOTINGS & BUILDING OVER REMOVED OR RETAINED TREES FOR THIS SITE OR **ADJACENT**


ASSET PROTECTION


BUILDER TO CONFIRM LOCATION OF ALL EXTERNAL ASSETS PRIOR TO COMMENCING CONSTRUCTION. RELOCATION MAY BE REQUIRED.

TERMITE NOTES

TERMITE PROTECTION MEASURES TO BE IN ACCORDANCE WITH NCC 2022 AND IN CONJUNCTION WITH AS3660.1.

- STRUCTURAL SLABS ON GROUND USED AS PART OF TERMITE BARRIER SYSTEMS MUST BE CONSTRUCTED IN ACCORDANCE WITH AS2870 AND GROUND IS TO BE PRE-TREATED WITH TERMITE SPRAY.
- THE EDGE OF ANY SLAB ON GROUND MAY BE USED AS A PERIMITER BARRIER PROVIDED 75mm OR MORE ABOVE GROUND IS LEFT EXPOSED.
- GROUND BENEATH NON-STRUCTURAL SLABS TO BE PRETREATED WITH TERMITE SPRAY.
- PENETRATIONS OF SLABS OR SLAB BEAMS TO BE PROTECTED.
- · ALL ATTACHMENTS TO BUILDINGS SUCH AS DOWNPIPES MUST MAINTAIN A CLEAR GAP TO ALLOW FOR VISUAL INSPECTION.
- SLAB EDGE TO BE TERMITE TREATED ANNUALLY FOR LIFE OF STRUCTURE.

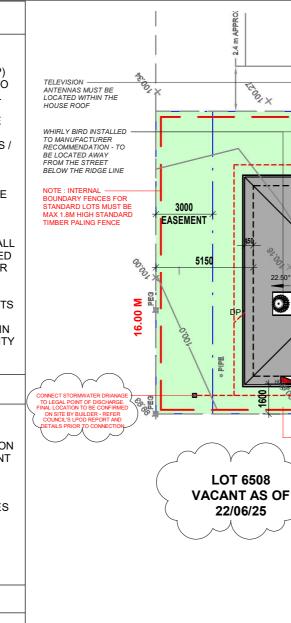

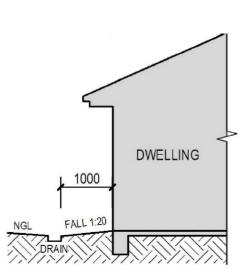

GRADE SURFACE AWAY FROM HOUSE FOR A MIN DISTANCE OF 1000MM AT A MIN 1:20 FALL TO DRAIN CONNECTED TO LEGAL POINT OF DISCHARGE

AREA SCHEDULE AREA (SQM) SQ'S NAME **PORCH** 5.51 SQM **GARAGE** 54.13 SQM GROUND FLOOR 213.03 SQM ALFRESCO 1 12.35 SQM ALFRESCO 2 17.74 SQM **GF TOTAL** 302.76 SQM FIRST FLOOR 261.63 SQM **TOTAL** 564.39 SQM (60.7 SQ) SITE AREA **594 SQM** SITE COVERAGE 50.9% POS 98.14 SQM **SPOS** 82.40 SQM **PERMEABILITY** 257.80 SQM (43.4%)

LOT 6506 **VACANT AS OF**

22/06/25

SELECTED COLORBOND

STANDARD LOTS MUST BE MAX 1.8M HIGH AND LEVEL WITH THE ADJACENT SIDE BOUNDARY FENCE. SIDE FENCE/GATE MUST BE TIMBER /

NOTE: INTERNAL BOUNDARY FENCES

UST BE MAX 1.8M HIGH

0

22.50°

FOR STANDARD LOTS MUST BE MAX 1.8M

35.05 M

22.50°

PROPOSED

RESIDENCE

SELECTED ROOF TILES

SFL - 100 590

37.88 M

NOTE: LOW EMISSION PAINTS AND SEALANTS ARE TO BE GREATER THAN 95% OF INTERNAL AND EXTERNAL PAINTED SURFACES.

THE BUILDER MUST COMPLETE ALL FIBRE CABLE ENTRY WORK IN ACCORDANCE WITH NBN **GUIDELINES.**

"CONTEMPORARY PACKAGE"

NOTE: LANSCAPE PLAN AS PER DEVELOPERS SPECIFICATION AND DESIGN GUIDELINES

NOTE: REFER ENERGY RATING REPORT FOR INSULATION VALUES

NOTE: CLIENT SELECTS DEVELOPER'S LANDSCAPE PACKAGE

IMPERMEABLE AREA SCHEDULE

NAME	AREA (SQM)		
FRONT GARDEN AREA	76.76 SQM (69.7%)		
DRIVEWAY	33.29 SQM (30.3%)		
TOTAL	110.05 SQM (100%)		



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CLIENT SIGN OFF: I / WE CONFIRM THAT THESE DRAWINGS ACCORD WITH OUR REQUIREMENTS AND AUTHORISE THEIR USE FOR NEXT STAGE PURPOSES

DATE DATE

PROPOSED NEW RESIDENCE

Lot 6507, BONNIEBROOK ROAD, BONNIEBROOK, VIC 3335

Lawrence Gilbert Makoona & Marie Tracy Lo Shun Shing

DRAWING SITE PLAN

SCALE: As indicated JOB NUMBER: 08206

17/05/2025

@A3

DATE

5220

CONCRETE

DRIVEWAY TO

ALIGN WITH

CROSSOVER

22.50°

3000

RETURN FENCE

NEAREST SIBACK

5820

Σ


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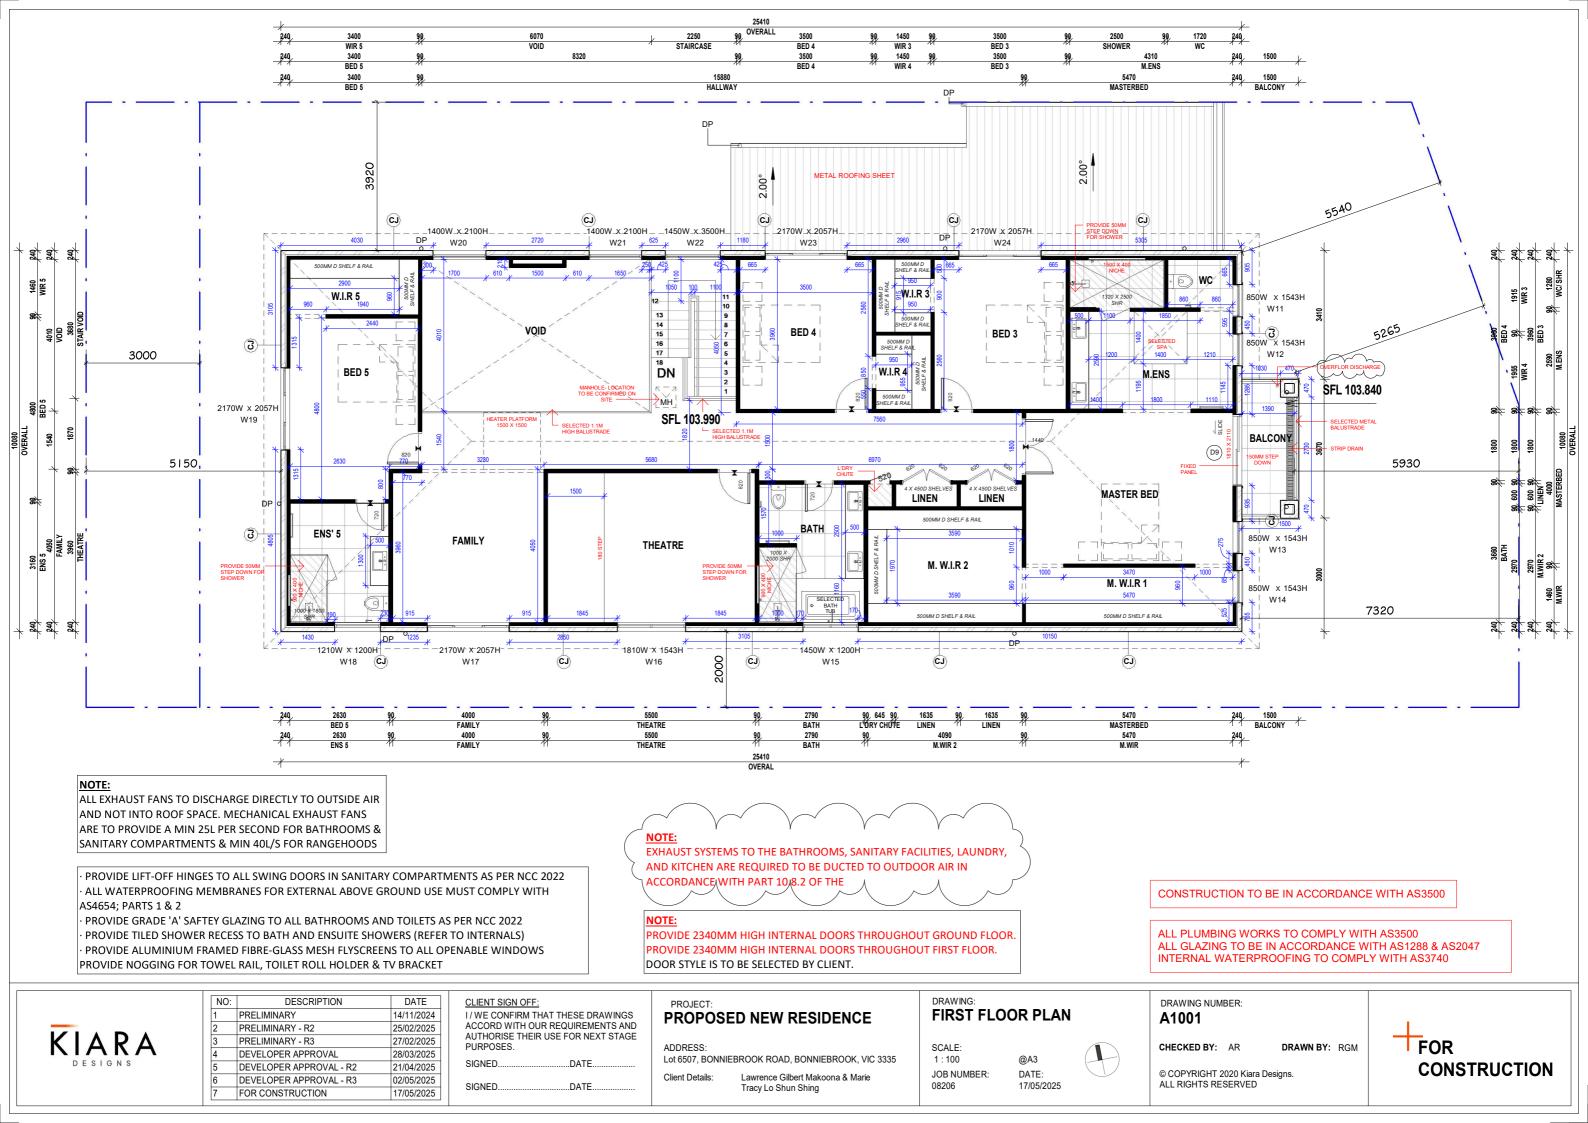
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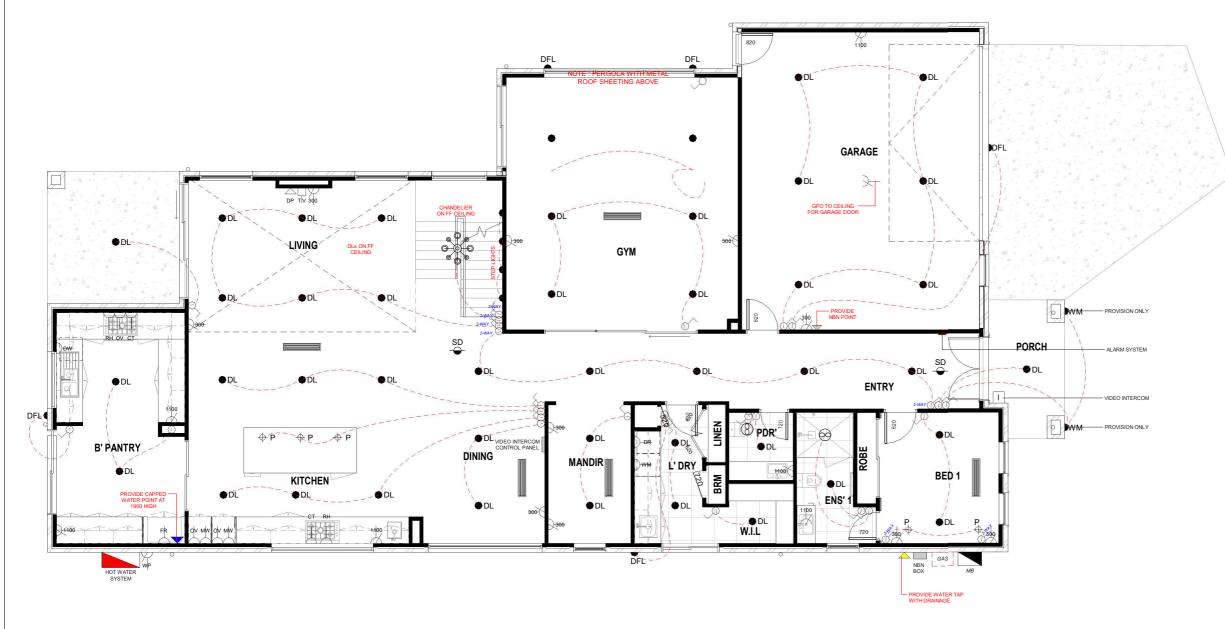
CHECKED BY: AR

DRAWN BY: RGM







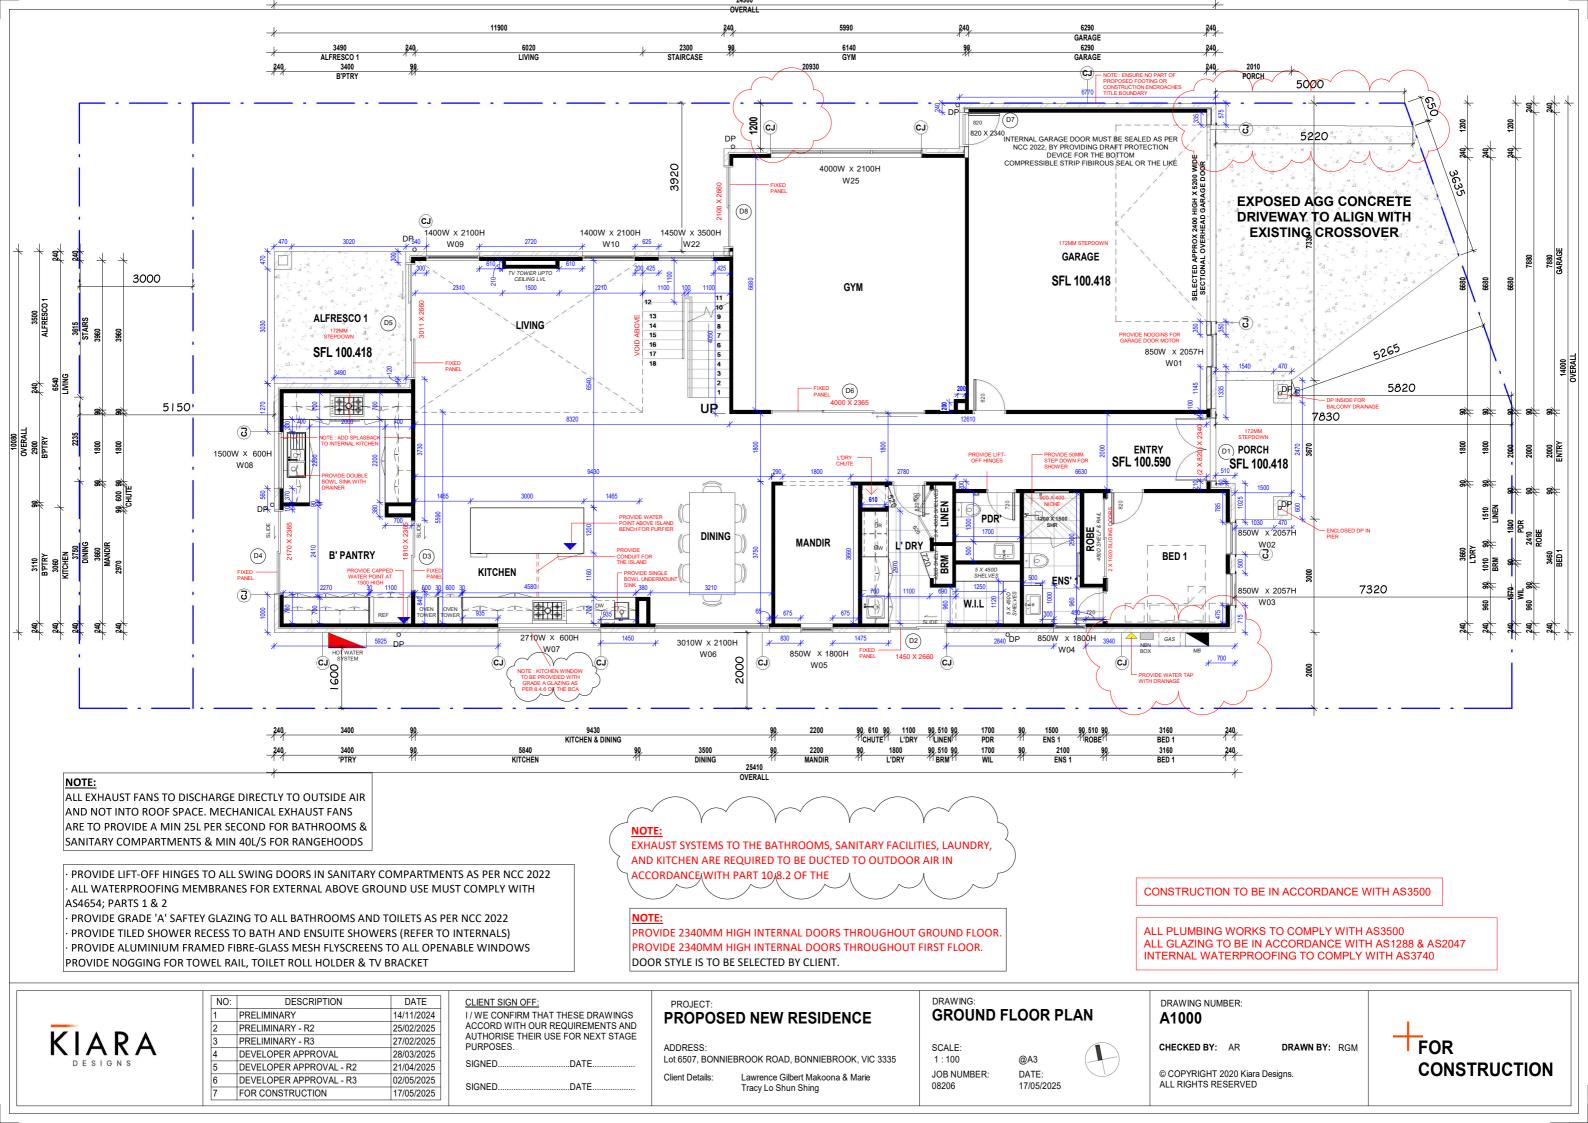

36 DOWNLIGHTS (85)

NOTE: ELECTRICAL FITTINGS AND FIXTURES - CLIENT TO CONFIRM LOCATION DURING COLOUR SELECTION

NOTES:

- T.V ANTENNA AND WIRING TO AERIAL POINTS AS SHOWN
- WHERE LAMPS ARE USED THAT HAVE A TRANSFORMER OR BALLAST, THE TRANSFORMER BALLAST MUST BE OF ELECTRICAL TYPE
- OUTDOOR LIGHTING MUST BE CONTROLLED BY A DAY SENSOR OR HAVE AT LEAST 40 LUMENS/W
- CONTRACTOR TO VERIFY LOCATION OF ALL POINTS ON SITE PRIOR TO FINAL INSTALLATION
- GPO'S TV POINT & DATA POINTS TO BE LOCATED TO SUIT FOR WALL MOUNTED TV (NOM 1200MM)
- TO "WC" PROVIDE MECHANICAL VENTILATION DUCTED TO EXTERNAL AIR
- HARD WIRED SMOKE ALARM WITH BATTERY BACK-UP TO AS3786-2014. ALL SMOKE ALARMS WITHIN DWELLING TO BE INTERCONNECTED TO EACH OTHER

GPO FOR RANGEHOOD GPO FOR DISHWASHER GPO FOR MICROWAVE GPO FOR MICROWAVE GPO FOR DRYER SWITCH POINT ALL LIGHT SWITCHES TO BE INSTALLED 1200 AFL UNLESS OTHERWISE INDICATED SMOKE DETECTOR HARDWIRED LOCATIONS TO THE APPROVAL OF BUILDING SURVEYOR WEATHERPROOF GPO DU DOWNLIGHT MINIMUM REQUIREMENTS: L'O TLED RECESSED CIRCULAR GIMBLE DOWNLIGHT SELECTED PENDANT LIGHT (PROVISION ONLY) BATTEN HOLDER TP TELEPHONE POINT DP DATA POINT T.V. WM WALL MOUNTED SCONCE (PROVISION ONLY) MB ELECTRICAL DISTRIBUTION/ SWITCH BOARD VIDEO INTERCOM PANEL EXHAUST FAN FLUORESCENT LIGHT NBN POINT WALL LIGHT DOUBLE FLOOD LIGHT LINEAR GRILL VENTS CHANDLIER			
GPO FOR DISHWASHER GPO FOR MICROWAVE GPO FOR DRYER SWITCH POINT ALLIGHT SWITCHES TO BE INSTALLED 1200 AFL UNLESS TWO WAY SWITCHING SMOKE DETECTOR HARDWIRED LOCATIONS TO THE APPROVAL OF BUILDING SURVEYOR WEATHERPROOF GPO DOWNLIGHT MINIMUM REQUIREMENTS: LIV OF LED RECESSED CIRCULAR GIMBLE DOWNLIGHT (PROVISION ONLY) BATTEN HOLDER TP TELEPHONE POINT DO DATA POINT T.V. WM WALL MOUNTED SCONCE (PROVISION ONLY) MB ELECTRICAL DISTRIBUTION/ SWITCH BOARD I VIDEO INTERCOM PANEL EXHAUST FAN FLUORESCENT LIGHT WEALL LIGHT DOUBLE FLOOD LIGHT LINEAR GRILL VENTS LINEAR GRILL VENTS		RH	GPO FOR RANGEHOOD
GPO FOR MICROWAVE GPO FOR DRYER SWITCH POINT ALL LICHT SWITCHES TO BE INSTALLED 1200 AFL UNLESS OTHERWISE INDICATED TWO WAY SWITCHING SMOKE DETECTOR HARDWIRED LOCATIONS TO THE APPROVAL OF BUILDING SURVEYOR WEATHERPROOF GPO DOWNLIGHT MINIMUM REQUIREMENTS: LV O' LEE RECESSED CIRCULAR GIMBLE DOWNLIGHT SELECTED PENDANT LIGHT (PROVISION ONLY) BATTEN HOLDER TELEPHONE POINT DP DATA POINT T.V. WM WALL MOUNTED SCONCE (PROVISION ONLY) BELECTRICAL DISTRIBUTION/ SWITCH BOARD VIDEO INTERCOM PANEL EXHAUST FAN FLUORESCENT LIGHT NBN POINT WL WALL LIGHT DOUBLE FLOOD LIGHT LINEAR GRILL VENTS		DW	GPO FOR DISHWASHER
SWITCH POINT ALLICHT SWITCHES TO BE INSTALLED 1200 AFL UNLESS OTHERWISE INDICATED TWO WAY SWITCHING SMOKE DETECTOR HARDWIRED LOCATIONS TO THE APPROVAL OF BUILDING SURVEYOR WEATHERPROOF GPO DU DOWNLIGHT MINIMUM REQUIREMENTS: LV or LED RECESSED CIRCULAR GIMBLE DOWNLIGHT P SELECTED PENDANT LIGHT (PROVISION ONLY) BATTEN HOLDER TP TELEPHONE POINT DATA POINT T.V. WM WALL MOUNTED SCONCE (PROVISION ONLY) MB ELECTRICAL DISTRIBUTION/ SWITCH BOARD I VIDEO INTERCOM PANEL EXHAUST FAN FLUORESCENT LIGHT NBN POINT WL WALL LIGHT DOUBLE FLOOD LIGHT LINEAR GRILL VENTS E LINEAR GRILL VENTS)	MW	GPO FOR MICROWAVE
ALL LIGHT SWITCHES TO BE INSTALLED 1200 AFL UNLESS OTHERWISE INDICATED 2 WAY TWO WAY SWITCHING SMOKE DETECTOR HARDWIRED LOCATIONS TO THE APPROVAL OF BUILDING SURVEYOR WP WEATHERPROOF GPO DOWNLIGHT MINIMUM REQUIREMENTS: LV O'LED RECESSED CIRCULAR GIMBLE DOWNLIGHT SELECTED PENDANT LIGHT (PROVISION ONLY) BATTEN HOLDER TP TELEPHONE POINT DP DATA POINT T.V. WMM WALL MOUNTED SCONCE (PROVISION ONLY) MB ELECTRICAL DISTRIBUTION/ SWITCH BOARD VIDEO INTERCOM PANEL EXHAUST FAN FLUORESCENT LIGHT NBN POINT WL WALL LIGHT DFL DOUBLE FLOOD LIGHT LINEAR GRILL VENTS		DR	GPO FOR DRYER
SMOKE DETECTOR HARDWIRED LOCATIONS TO THE APPROVAL OF BUILDING SURVEYOR WEATHERPROOF GPO DOWNLIGHT MINIMUM REQUIREMENTS: LV or LED RECESSED CIRCULAR GIMBLE DOWNLIGHT SELECTED PENDANT LIGHT (PROVISION ONLY) BATTEN HOLDER TP TELEPHONE POINT DP DATA POINT T.V. WM WALL MOUNTED SCONCE (PROVISION ONLY) BELECTRICAL DISTRIBUTION/ SWITCH BOARD VIDEO INTERCOM PANEL EXHAUST FAN FLUORESCENT LIGHT NBN POINT WALL LIGHT DOUBLE FLOOD LIGHT LINEAR GRILL VENTS		σ^	ALL LIGHT SWITCHES TO BE INSTALLED 1200 AFL UNLESS
WEATHERPROOF GPO DOWNLIGHT MINIMUM REQUIREMENTS: LV or LED RECESSED CIRCULAR GIMBLE DOWNLIGHT (PROVISION ONLY) BATTEN HOLDER TELEPHONE POINT DOP DATA POINT T.V. WMALL MOUNTED SCONCE (PROVISION ONLY) BECTRICAL DISTRIBUTION/ SWITCH BOARD VIDEO INTERCOM PANEL EXHAUST FAN FLUORESCENT LIGHT NBN POINT WALL LIGHT DOUBLE FLOOD LIGHT LINEAR GRILL VENTS		2 WAY	TWO WAY SWITCHING
DOWNLIGHT MINIMUM REQUIREMENTS: LV or LED RECESSED CIRCULAR GIMBLE DOWNLIGHT P SELECTED PENDANT LIGHT (PROVISION ONLY) BATTEN HOLDER TP TELEPHONE POINT DP DATA POINT T.V. WMM WALL MOUNTED SCONCE (PROVISION ONLY) BECTRICAL DISTRIBUTION/ SWITCH BOARD VIDEO INTERCOM PANEL EXHAUST FAN FLUORESCENT LIGHT NBN POINT WALL LIGHT DOUBLE FLOOD LIGHT LINEAR GRILL VENTS		⇔ SD	
MINIMUM REQUIREMENTS: LV or LED RECESSED CIRCULAR GIMBLE DOWNLIGHT SELECTED PENDANT LIGHT (PROVISION ONLY) BATTEN HOLDER TP TELEPHONE POINT DP DATA POINT T.V. WM WALL MOUNTED SCONCE (PROVISION ONLY) BELECTRICAL DISTRIBUTION/ SWITCH BOARD VIDEO INTERCOM PANEL EXHAUST FAN FLUORESCENT LIGHT NBN POINT WALL LIGHT DOUBLE FLOOD LIGHT LINEAR GRILL VENTS		↓WP	WEATHERPROOF GPO
## (PROVISION ONLY) BATTEN HOLDER TELEPHONE POINT DATA POINT T.V. WM WALL MOUNTED SCONCE (PROVISION ONLY) BELECTRICAL DISTRIBUTION/SWITCH BOARD VIDEO INTERCOM PANEL EXHAUST FAN FLUORESCENT LIGHT NBN POINT WL WALL LIGHT DOUBLE FLOOD LIGHT LINEAR GRILL VENTS		● ^{DL}	MINIMUM REQUIREMENTS:
TP TELEPHONE POINT □ DP DATA POINT □ TV T.V. WM WALL MOUNTED SCONCE (PROVISION ONLY) MB ELECTRICAL DISTRIBUTION/ SWITCH BOARD □ VIDEO INTERCOM PANEL EXHAUST FAN FLUORESCENT LIGHT NBN POINT WL WALL LIGHT DOUBLE FLOOD LIGHT LINEAR GRILL VENTS		₽	
DP DATA POINT T.V. WM WALL MOUNTED SCONCE (PROVISION ONLY) BELECTRICAL DISTRIBUTION/SWITCH BOARD VIDEO INTERCOM PANEL EXHAUST FAN FLUORESCENT LIGHT NBN POINT WL WALL LIGHT DOUBLE FLOOD LIGHT LINEAR GRILL VENTS		0	BATTEN HOLDER
T.V. WM WALL MOUNTED SCONCE (PROVISION ONLY) BELECTRICAL DISTRIBUTION/SWITCH BOARD VIDEO INTERCOM PANEL EXHAUST FAN FLUORESCENT LIGHT NBN POINT WL WALL LIGHT DOUBLE FLOOD LIGHT LINEAR GRILL VENTS		√ TP	TELEPHONE POINT
WM WALL MOUNTED SCONCE (PROVISION ONLY) MB ELECTRICAL DISTRIBUTION/ SWITCH BOARD VIDEO INTERCOM PANEL EXHAUST FAN FLUORESCENT LIGHT NBN POINT WL WALL LIGHT DOUBLE FLOOD LIGHT LINEAR GRILL VENTS		< DP	DATA POINT
(PROVISION ONLY) MB ELECTRICAL DISTRIBUTION/ SWITCH BOARD VIDEO INTERCOM PANEL EXHAUST FAN FLUORESCENT LIGHT NBN POINT WL WALL LIGHT DOUBLE FLOOD LIGHT LINEAR GRILL VENTS		<u></u> ¬⊤ν	T.V.
SWITCH BOARD VIDEO INTERCOM PANEL EXHAUST FAN FLUORESCENT LIGHT NBN POINT WL WALL LIGHT DOUBLE FLOOD LIGHT LINEAR GRILL VENTS		wm	
EXHAUST FAN FLUORESCENT LIGHT NBN POINT WL WALL LIGHT DOUBLE FLOOD LIGHT LINEAR GRILL VENTS		МВ	
FLUORESCENT LIGHT NBN POINT WL WALL LIGHT DOUBLE FLOOD LIGHT LINEAR GRILL VENTS			VIDEO INTERCOM PANEL
NBN POINT WL WALL LIGHT DOUBLE FLOOD LIGHT LINEAR GRILL VENTS		⊗ _{EX}	EXHAUST FAN
WALL LIGHT DOUBLE FLOOD LIGHT LINEAR GRILL VENTS		Н	FLUORESCENT LIGHT
DOUBLE FLOOD LIGHT LINEAR GRILL VENTS			NBN POINT
LINEAR GRILL VENTS		WL	WALL LIGHT
		DFL	DOUBLE FLOOD LIGHT
CHANDLIER			LINEAR GRILL VENTS
			CHANDLIER

DOUBLE GENERAL POWER OUTLET. XXX DENOTES HEIGHT IN mm AFL

GPO FOR REFIGERATOR

GPO FOR WASHING MACHINE

GPO FOR OVEN



	NO:	DESCRIPTION	DATE
	1	PRELIMINARY	14/11/2024
	2	PRELIMINARY - R2	25/02/2025
	3	PRELIMINARY - R3	27/02/2025
	4	DEVELOPER APPROVAL	28/03/2025
	5	DEVELOPER APPROVAL - R2	21/04/2025
6 DEVELOPER AF		DEVELOPER APPROVAL - R3	02/05/2025
	7	FOR CONSTRUCTION	17/05/2025

CLIENT SIGN OFF: I/WE CONFIRM THAT THESE DRAWINGS ACCORD WITH OUR REQUIREMENTS AND AUTHORISE THEIR USE FOR NEXT STAGE PURPOSES.

..DATE.

PROPOSED NEW RESIDENCE

Lot 6507, BONNIEBROOK ROAD, BONNIEBROOK, VIC 3335 Lawrence Gilbert Makoona & Marie Tracy Lo Shun Shing

DRAWING: **ELECTRICAL PLAN**

DATE:

SCALE: 1:100 JOB NUMBER: 08206



DRAWING NUMBER: A1002

DRAWN BY: RS CHECKED BY: AR





49 DOWNLIGHTS (85)

NOTE: ELECTRICAL FITTINGS AND FIXTURES - CLIENT TO CONFIRM LOCATION DURING COLOUR SELECTION

NOTES:

- T.V ANTENNA AND WIRING TO AERIAL POINTS AS SHOWN
- WHERE LAMPS ARE USED THAT HAVE A TRANSFORMER OR BALLAST, THE TRANSFORMER BALLAST MUST BE OF ELECTRICAL TYPE
- OUTDOOR LIGHTING MUST BE CONTROLLED BY A DAY SENSOR OR HAVE AT LEAST 40 LUMENS/W
- CONTRACTOR TO VERIFY LOCATION OF ALL POINTS ON SITE PRIOR TO FINAL INSTALLATION
- GPO'S TV POINT & DATA POINTS TO BE LOCATED TO SUIT FOR WALL MOUNTED TV (NOM 1200MM)
- TO "WC" PROVIDE MECHANICAL VENTILATION DUCTED TO EXTERNAL AIR
- HARD WIRED SMOKE ALARM WITH BATTERY BACK-UP TO AS3786-2014. ALL SMOKE ALARMS WITHIN DWELLING TO BE INTERCONNECTED TO EACH OTHER

→ MW → DR	GPO FOR DISHWASHER GPO FOR MICROWAVE GPO FOR DRYER
DR	
	GPO FOR DRYER
0^	
	SWITCH POINT ALL LIGHT SWITCHES TO BE INSTALLED 1200 AFL UNLESS OTHERWISE INDICATED
2 WAY	TWO WAY SWITCHING
∳ SD	SMOKE DETECTOR HARDWIRED LOCATIONS TO THE APPROVAL OF BUILDING SURVEYOR
WP	WEATHERPROOF GPO
● ^{DL}	DOWNLIGHT MINIMUM REQUIREMENTS: LV or LED RECESSED CIRCULAR GIMBLE DOWNLIGHT
→ ^P	SELECTED PENDANT LIGHT (PROVISION ONLY)
	BATTEN HOLDER
< TP	TELEPHONE POINT
< DP	DATA POINT
□— TV	T.V.
WM	WALL MOUNTED SCONCE (PROVISION ONLY)
МВ	ELECTRICAL DISTRIBUTION/ SWITCH BOARD
1	VIDEO INTERCOM PANEL
⊗ _{EX}	EXHAUST FAN
\vdash	FLUORESCENT LIGHT
	NBN POINT
WL	WALL LIGHT
DFL	DOUBLE FLOOD LIGHT
	LINEAR GRILL VENTS
	CHANDLIER

DOUBLE GENERAL POWER OUTLET. XXX DENOTES HEIGHT IN mm AFL

GPO FOR REFIGERATOR

GPO FOR RANGEHOOD

GPO FOR WASHING MACHINE

GPO FOR OVEN



NO:	DESCRIPTION	DATE
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7	FOR CONSTRUCTION	17/05/2025

CLIENT SIGN OFF: I/WE CONFIRM THAT THESE DRAWINGS ACCORD WITH OUR REQUIREMENTS AND AUTHORISE THEIR USE FOR NEXT STAGE PURPOSES.

.DATE. ..DATE..

PROPOSED NEW RESIDENCE

Lot 6507, BONNIEBROOK ROAD, BONNIEBROOK, VIC 3335

Lawrence Gilbert Makoona & Marie Tracy Lo Shun Shing

ELECTRICAL PLAN

SCALE: 1:100 JOB NUMBER: DATE: 08206 17/05/2025


DRAWING:



DRAWING NUMBER: A1003

DRAWN BY: RS CHECKED BY: AR

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NOTE - THIS DRAWING IS ONLY FOR INFORMATION AND NOT TO USE FOR CONSTRUCTION - CONTRACTOR MUST VERIFY ALL DIMENSIONS IN CONJUNCTION WITH OTHER DRAWINGS NOT LIMITED TO FLOOR PLANS & JOINERY DRAWINGS ON SITE PRIOR TO SETOUT AND POUR THE CONCRETE SLAB.

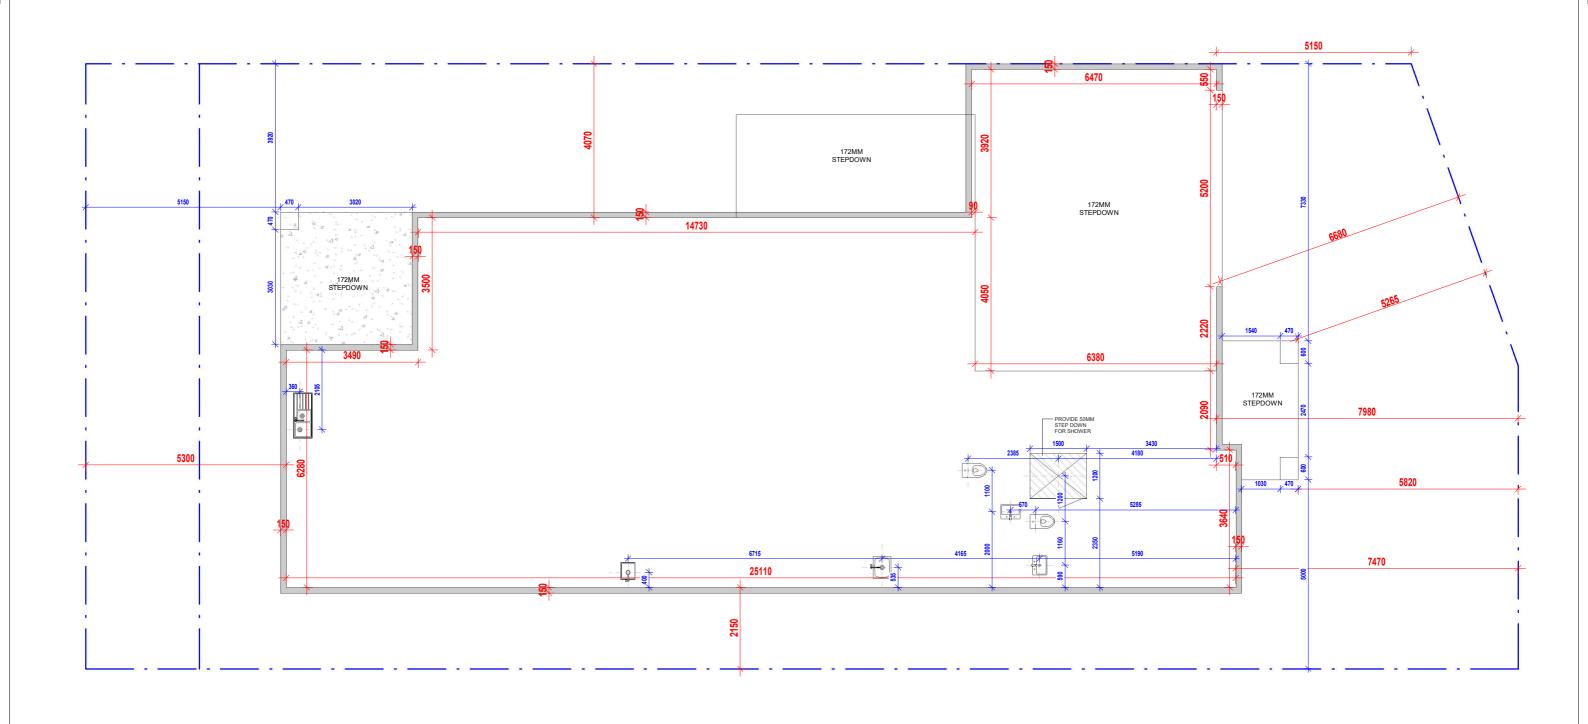

NO:	DESCRIPTION	DATE	
NO: DESCRIPTION		DATE	
1	PRELIMINARY	14/11/2024	
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5	DEVELOPER APPROVAL - R2	21/04/2025	
6	DEVELOPER APPROVAL - R3	02/05/2025	
7	FOR CONSTRUCTION	17/05/2025	

CLIENT SIGN OFF:

I/WE CONFIRM THAT THESE DRAWINGS
ACCORD WITH OUR REQUIREMENTS AND
AUTHORISE THEIR USE FOR NEXT STAGE
PURPOSES.

SIGNED......DATE......

PROPOSED NEW RESIDENCE

ADDRESS:

Lot 6507, BONNIEBROOK ROAD, BONNIEBROOK, VIC 3335

Client Details: Lawrence Gilbert Makoona & Marie
Tracy Lo Shun Shing

DRAWING: SLAB SETOUT PLAN


SCALE: 1:100

1:100 @A3 JOB NUMBER: DATE: 08206 17/05/2025 DRAWING NUMBER: **A1004**

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CHECKED BY: AR DRAWN BY: RS

FOR CONSTRUCTION

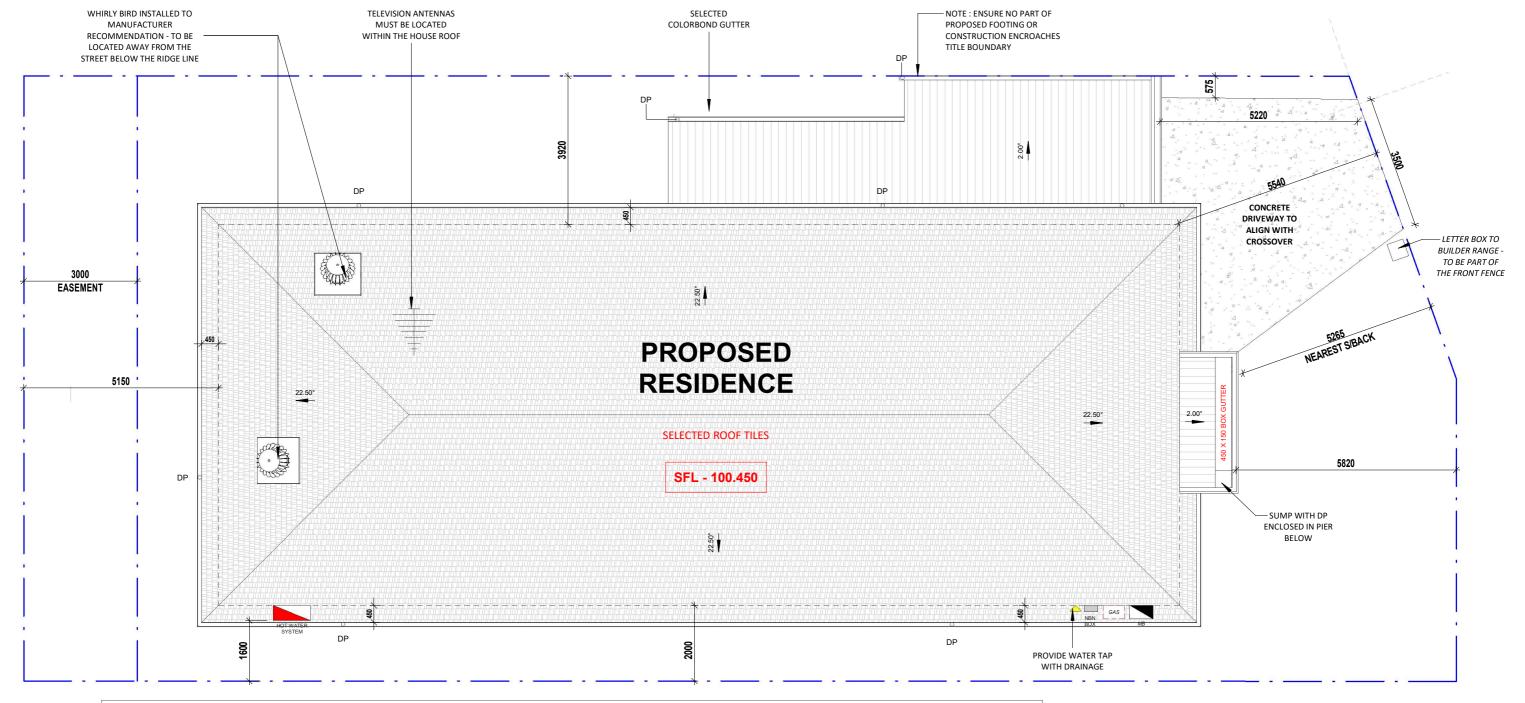

ROOF PLAN NOTES:

- SELECTED TILED ROOF TO BE INSTALLED IN ACCORDANCE WITH MANUFACTURER'S INSTALLATION INSTRUCTIONS & AS1562.1 DESIGN & INSTALLATION OF SHEET ROOF & WALL CLADDING
- WORKERS ARE TO DETERMINE SAFE MANUAL & MECHANICAL HANDLING , LIFTING & INSTALLATION OF ARCHITECTURAL FIXTURES & COMPONENTS WHILE FOLLOWING WHS INSTRUCTIONS ON MANUFACTURER'S DOCUMENTATION
- INSTALL ALL ROOFING COMPONENTS AS PER MANUFACTURER'S INSTRUCTIONS FOR LHL REQUIREMENTS & WIND CLASSIFICATION N2 REQUIREMENTS THE PROPOSED ROOFING MUST BE INSTALLED TO PREVENT WATER PENETRATION INTO THE **BUILDING STRUCTURE (NCC 2022)**
- ALL SARKING MATERIAL TO BE INSTALLED ACCORDING TO MANUFACTURER'S INSTALLATION INSTRUCTIONS & AS/NZS4200 INSTALLATION OF PLIABLE MEMBRANE AND UNDERLAY (NCC 2022) & HAVE A MAXIMUM 5 FLAMMABILITY INDEX (NCC 2022)
- CORROSION PROTECTION OF METAL ROOF SHEETING IS REQUIRED TO MEET WITH MINIMUM COATING REQUIREMENTS OF MANUFACTURER
- GUTTERS, DOWNPIPES & FLASHINGS FABRICATED WITH METAL ARE TO MEET AS/NZS2179 REQUIREMENTS WHILE UPVC COMPONENTS ARE TO COMPLY WITH AS1273
- NO LEAD ROOFING PRODUCTS ARE SPECIFIED TO PREVENT TOXINS FROM ENTERING ANY POTENTIALLY POTABLE RAINWATER CATCHMENT SUPPLIES (NCC 2022) EAVES GUTTERS MUST HAVE A 1:500 MINIMUM FALL (NCC 2022) & DESIGNED TO ARI20 (NCC 2022)
- ANY FLEXIBLE DUCTING THAT HAS A SOURCE FROM A FLAME HAZARD MUST MEET AS4254 HAZARD PROPERTIES
- PROVIDE DEKTITE PIPE FLASHING OR SIMILAR TO ROOF PIPE PENETRATIONS. INSTALL IN STRICT ACCORDANCE WITH MANUFACTURER'S RECOMMENDATIONS, PROVING FREE DRAINAGE OF WATER FROM AROUND AREAS OF INSTALLATION
- RECOMMEND BUILDER HAVE CERTIFIED ROOF ANCHORAGE DESIGN & INSTALLATION TO AS 1891.4 2000. BUILDING OWNER IS TO ENSURE ANNUAL MAINTENANCE & INSPECTION OF SYSTEM
- THE BUILDER IS TO TAKE CARE NOT TO CONTAMINATE COLORBOND SURFACES WITH SUNSCREENS AS THESE HAVE SHOWN TO DAMAGE THE SURFACE FINISH
- ROOF SHEETS TO BE LAPPED AWAY FROM PREVAILING WEATHER INGRESS (NCC 2022)
- ROOF TILES WITH APPROVED FLASHING ON BATTERNS @ 330mm MAX CTRS ON SELECTED TIMBER FRAMED ROOF TRUSSES BY MANUFACTURERS DETAIL AND SPECIFICATION. ALSO COVER TOP OF TRUSSES WITH REFLECTIVE FOIL LAMINATE THRU-
- 90mm TIMBER FRAMED WALL WITH SELECTED STUDS @ 450 CTRS MAX WITH INSULATION PLACED BETWEEN WALL STUDS ON EXTERNAL WALLS. ALSO WRAP OUTSIDE OF STUD FRAME WITH REFLECTIVE FOIL LAMINATE THROUGHOUT.
- PLASTERBOARD 10mm ON SELECTED CEILING BATTERNS, TYPICAL, ON TRUSSES WITH BULK INSULATION PLACED BETWEEN TRUSS BOTTOM CORDS.

PLUMBER REQUIREMENTS



NO:	DESCRIPTION	DATE		
1	PRELIMINARY	14/11/2024		
2	2 PRELIMINARY - R2			
3	PRELIMINARY - R3	27/02/2025		
4	DEVELOPER APPROVAL	28/03/2025		
5	DEVELOPER APPROVAL - R2	21/04/2025		
6	DEVELOPER APPROVAL - R3	02/05/2025		
7	FOR CONSTRUCTION	17/05/2025		

I / WE CONFIRM THAT THESE DRAWINGS ACCORD WITH OUR REQUIREMENTS AND AUTHORISE THEIR USE FOR NEXT STAGE PURPOSES.

..DATE.. SIGNED. ..DATE..

PROPOSED NEW RESIDENCE

Lot 6507, BONNIEBROOK ROAD, BONNIEBROOK, VIC 3335

Lawrence Gilbert Makoona & Marie Tracy Lo Shun Shing

DRAWING: **ROOF PLAN**

SCALE: As indicated

08206

JOB NUMBER: DATE: 17/05/2025 A1005


CHECKED BY: AR

DRAWN BY: RS

NOTE: FINAL LOCATION OF DOWNPIPES TO

BE CONFIRMED ON SITE AS PER THE



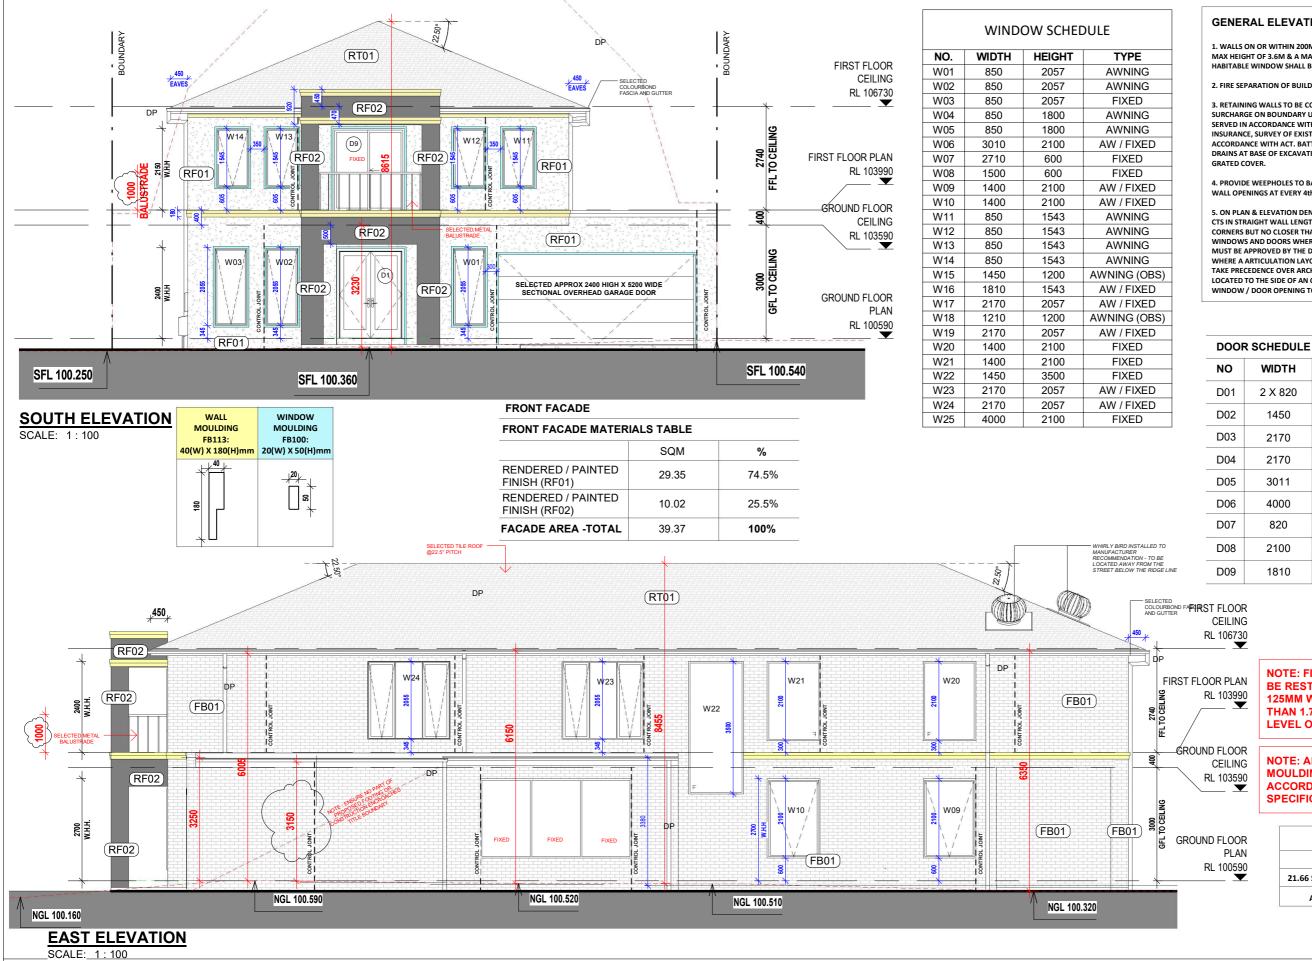

GENERAL ELEVATION NOTES

1. WALLS ON OR WITHIN 200MM OF BOUNDARIES TO COMPLY WITH RESCODE CLAUSE 54 A.11-13. MAX HEIGHT OF 3.6M & A MAX AVG. HEIGHT OF 3.20M. MIN 1.00M LIGHT COURT TO NEIGHBOURS HABITABLE WINDOW SHALL BE PROVIDED. NO PART OF BUILDING TO ENCROACH BOUNDARY.

2. FIRE SEPARATION OF BUILDINGS ON BOUNDARY IN ACCORDANCE WITH NCC 2022.

3. RETAINING WALLS TO BE CONSTRUCTED IMMEDIATELY AFTER EXCAVATION. ALLOW 5KPa SURCHARGE ON BOUNDARY U.N.O. RETAINING WALLS TO BE CONSTRUCTED & PROTECTION NOTICE SERVED IN ACCORDANCE WITH BUILDING ACT 1993, OWNER/CONTRACTOR IS TO PROVIDE INSURANCE, SURVEY OF EXISTING CONDITIONS & NEIGHBOUR'S CONSENT FOR CONSTRUCTION IN ACCORDANCE WITH ACT. BATTERS ARE AT 45° & THATCHED OR LANDSCAPED U.N.O. CUT OFF DRAINS AT BASE OF EXCAVATION TO CONNECT TO STORM WATER DRAINS VIA SILT PIT WITH

4. PROVIDE WEEPHOLES TO BASE OF ALL BRICK VENEER WALLS & ABOVE EXTERNAL BRICK VENEER WALL OPENINGS AT EVERY 4th PERPEND. PROVIDE SUITABLE CONTINUOUS CAVITY FLASHING

5. ON PLAN & ELEVATION DENOTES ARTICULATION JOINTS. THESE SHALL BE PLACED AT MAX. 5.0m CTS IN STRAIGHT WALL LENGTHS OR AS SPECIFIED BY THE SOIL REPORT MAXIMUM 3.0m FROM CORNERS BUT NO CLOSER THAN 600mm. THEY MUST BE FULL HEIGHT OF WALL AND PLACED BESIDE WINDOWS AND DOORS WHERE POSSIBLE. CONSTRUCTION METHOD OR CHANGE OF LOCATION MUST BE APPROVED BY THE DESIGNER OR THE OWNERS.

WHERE A ARTICULATION LAYOUT HAS BEEN PROVIDED BY A STRUCTURAL ENGINEER, THAT SHALL TAKE PRECEDENCE OVER ARCHITECTURAL DOCUMENTS, WHERE ARTICULATION IOINTS ARE LOCATED TO THE SIDE OF AN OPENING SUFFICIENT CLEARANCE MUST BE PROVIDED TO THE WINDOW / DOOR OPENING TO ALLOW FOR MOVEMENT.

NO	WIDTH	HEIGHT	FRAME	TYPE
D01	2 X 820	2340	TIMBER	HINGED / DOUBLE
D02	1450	2660	ALUMINIUM	SLIDING
D03	2170	2365	ALUMINIUM	SLIDING
D04	2170	2365	ALUMINIUM	SLIDING
D05	3011	2660	ALUMINIUM	SLIDING
D06	4000	2365	ALUMINIUM	INTERNAL SLIDING
D07	820	2340	TIMBER	HINGED
D08	2100	2660	ALUMINIUM	SLIDING
D09	1810	2110	ALUMINIUM	SLIDING

NOTE: FIRST FLOOR WINDOWS ARE TO **BE RESTRICTED TO OPEN LESS THAN** 125MM WHERE THE SILL LEVEL IS LESS THAN 1.7M ABOVE FINISHED FLOOR LEVEL OF THE ROOM

NOTE: ALL SELECTED EXTERNAL MOULDINGS AND TRIMS FIXED **ACCORDING TO MANUFACTURER'S SPECIFICATION**

	PART	5 - REGULAT	TION 8	0
TOTAL AREA			-	21.66 SQM
21.66 SQM	/	=	3.20 M	
AVG. W	/ALL HEI	=	3.20 M	



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CLIENT SIGN OFF: I/WE CONFIRM THAT THESE DRAWINGS ACCORD WITH OUR REQUIREMENTS AND AUTHORISE THEIR USE FOR NEXT STAGE

PURPOSES.

SIGNED... ..DATE. SIGNED.. ..DATE..

PROPOSED NEW RESIDENCE

Lot 6507, BONNIEBROOK ROAD, BONNIEBROOK, VIC 3335

Lawrence Gilbert Makoona & Marie Tracy Lo Shun Shing

DRAWING: **ELEVATIONS**

SCALE:

As indicated @A3 JOB NUMBER: DATE: 08206 17/05/2025




DRAWING NUMBER:

A2000

CHECKED BY: AR DRAWN BY: RGM



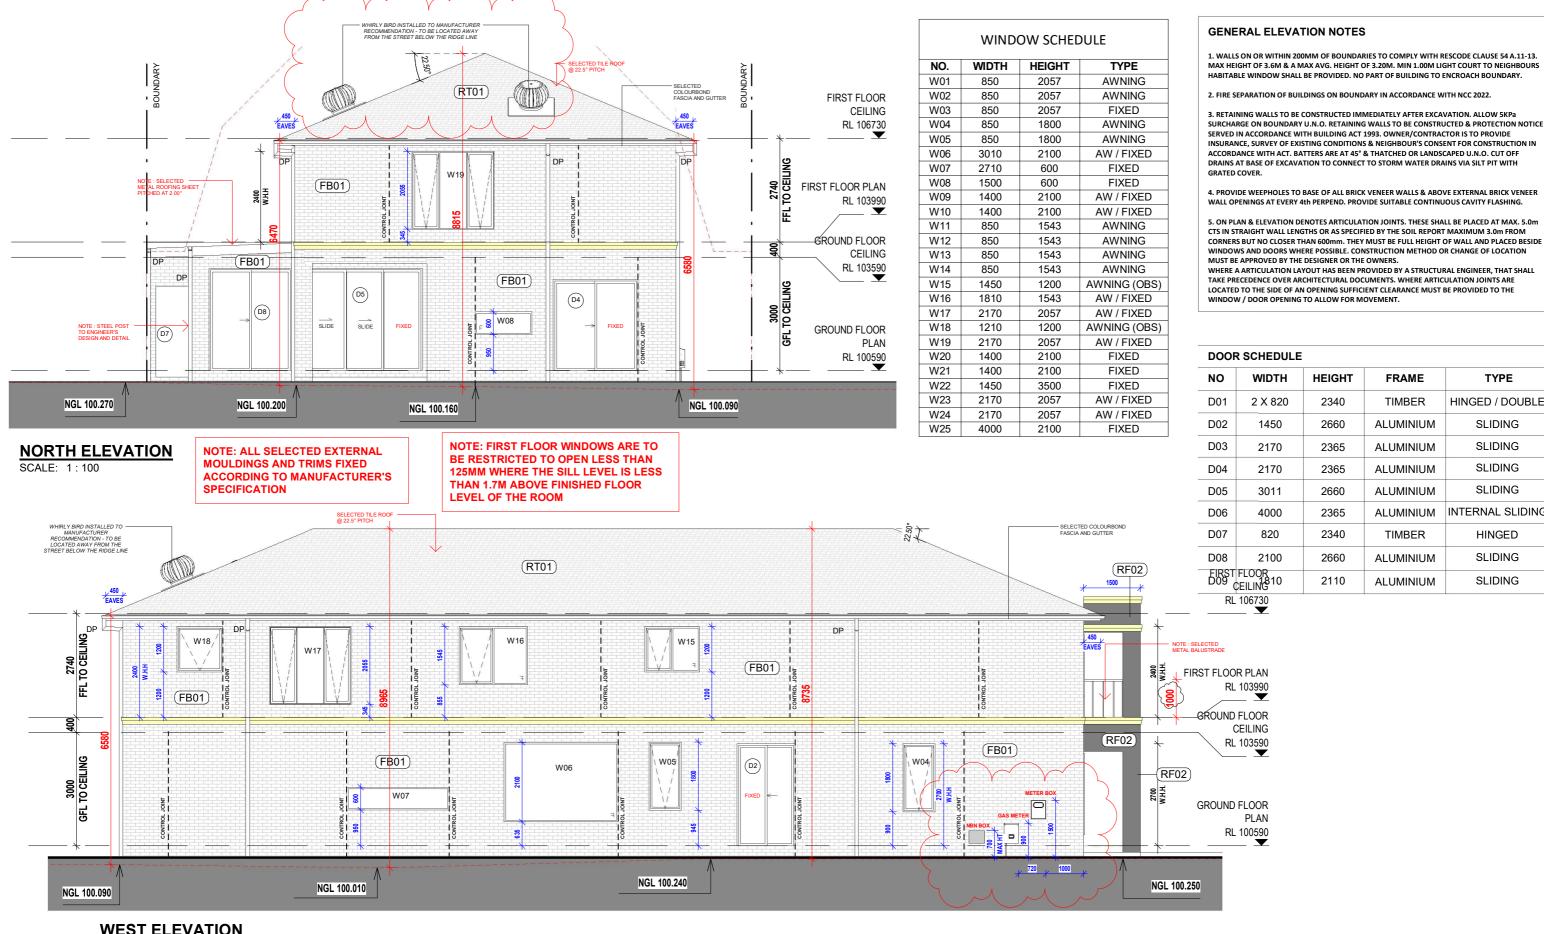

WEST ELEVATION

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1	10:	DESCRIPTION	DATE
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SIGNED... ..DATE. SIGNED.. ..DATE..

PROPOSED NEW RESIDENCE

Lot 6507, BONNIEBROOK ROAD, BONNIEBROOK, VIC 3335

Lawrence Gilbert Makoona & Marie Tracy Lo Shun Shing

DRAWING: **ELEVATIONS**

SCALE: As indicated

@A3 JOB NUMBER: DATE: 08206 17/05/2025



DRAWING NUMBER:

A2001

CHECKED BY: AR

DRAWN BY: RGM

HEIGHT

2340

2660

2365

2365

2660

2365

2340

2660

2110

FRAME

TIMBER

ALUMINIUM

ALUMINIUM

ALUMINIUM

ALUMINIUM

ALUMINIUM

TIMBER

ALUMINIUM

ALUMINIUM

TYPE

HINGED / DOUBLE

SLIDING

SLIDING

SLIDING

SLIDING


INTERNAL SLIDING

HINGED

SLIDING

SLIDING



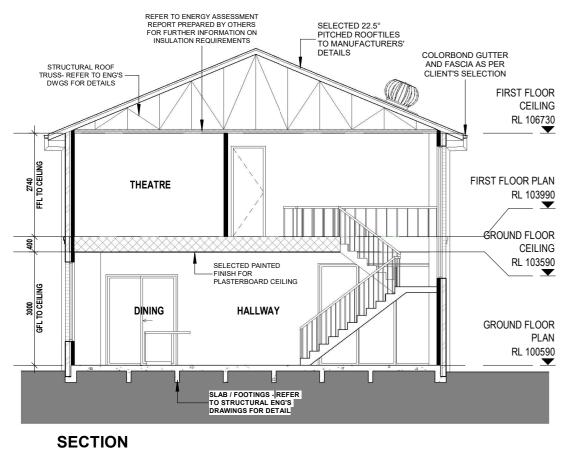

NOTES:

- VAPOUR PERMEABLE MEMBRANE MUST BE INSTALLED ON THE EXTERIOR SIDE OF THE PRIMARY INSULATION LAYER OF WALL ASSEMBLIES THAT FORM THE EXTERNAL ENVELOPE OF BUILDING IN **ACCORDANCE WITH NCC 2022**
- ARTICULATATION JOINTS TO FOLLOW DOWN THE SIDE OF WINDOWS.
- WEEP HOLES TO BE 150MM FROM NATURAL GROUND LEVEL AND TO **GRADE AWAY FOR 1M.**
- ROOF TILES MUST OVERHANG THE FASCIA OR TILING BATTEN BY NOT LESS THAN 35mm IN ACCORDANCE WITH 3.5.2.4 NCC 2022.

FLASHING:


THE FOLLOWING FOR FLASHING REQUIREMENTS:

- A) ROOF TILE FLASHING SHALL BE IN ACCORDANCE WITH PART NCC 2022.
- B) FLASHINGS TO WALL OPENINGS SHALL BE IN ACCORDANCE WITH PART NCC 2022.

EXHAUST FAN NOTES:

EXHAUST FAN DISCHARGE RATES:

- A) SANITARY COMPARTMENTS AND BATHROOMS: 251/S
- B) KITCHEN AND LAUNDRY: 401/S.
- C) FLOW RATE AND DISCHARGE OF EXHAUST SYSTEMS IN ACCORDANCE WITH NCC 2022.

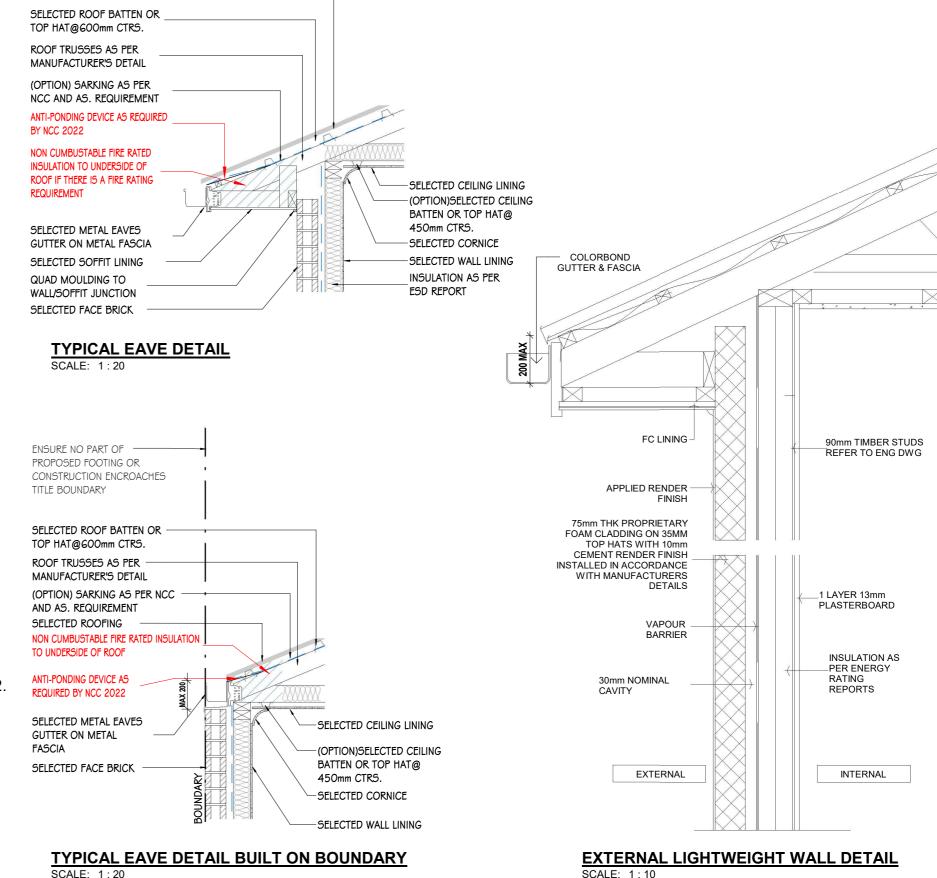



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DATE SIGNED. .DATE.

PROPOSED NEW RESIDENCE

SELECTED ROOFING

Lot 6507, BONNIEBROOK ROAD, BONNIEBROOK, VIC 3335 Lawrence Gilbert Makoona & Marie

Tracy Lo Shun Shing

DRAWING: SECTION

SCALE: As indicated JOB NUMBER: DATE: 08206 17/05/2025





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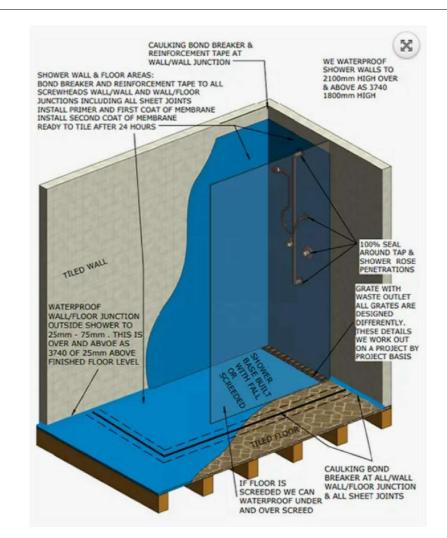
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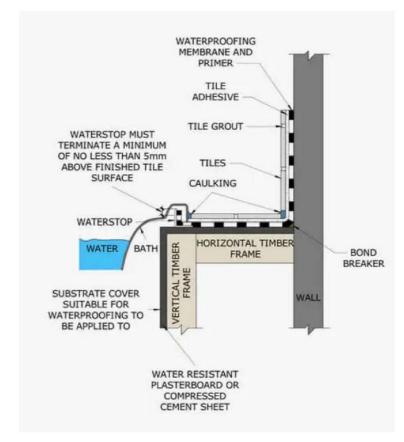
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NO:	DESCRIPTION	DATE	
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6	DEVELOPER APPROVAL - R3	02/05/2025	
7	FOR CONSTRUCTION	17/05/2025	

SLAB REBATE DETAIL

CLIENT SIGN OFF:

I/WE CONFIRM THAT THESE DRAWINGS
ACCORD WITH OUR REQUIREMENTS AND
AUTHORISE THEIR USE FOR NEXT STAGE
PURPOSES.

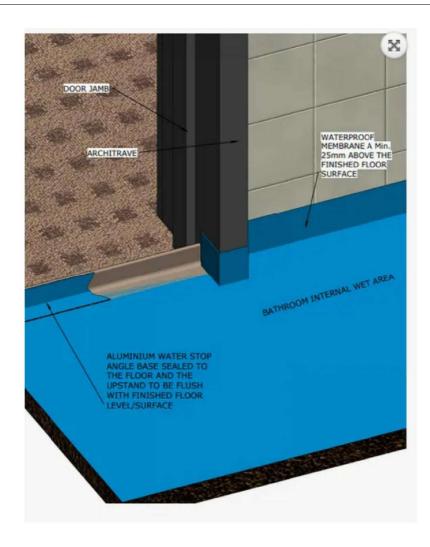SIGNED.....DATE.....

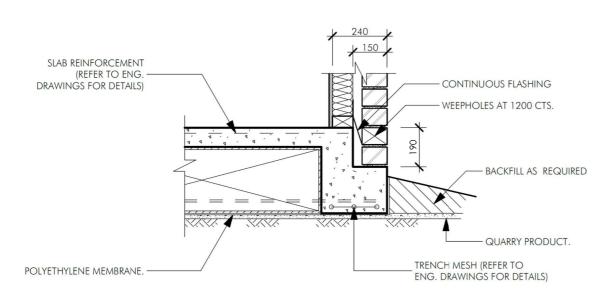PROPOSED NEW RESIDENCE

ADDRESS.

Lot 6507, BONNIEBROOK ROAD, BONNIEBROOK, VIC 3335

Lawrence Gilbert Makoona & Marie Tracy Lo Shun Shing

DRAWING: TYPICAL DETAIL

SCALE: 1:15

1:15 @A3


JOB NUMBER: DATE:
08206 17/05/2025

DRAWING NUMBER: A3001

CHECKED BY: AR

DRAWN BY: RS



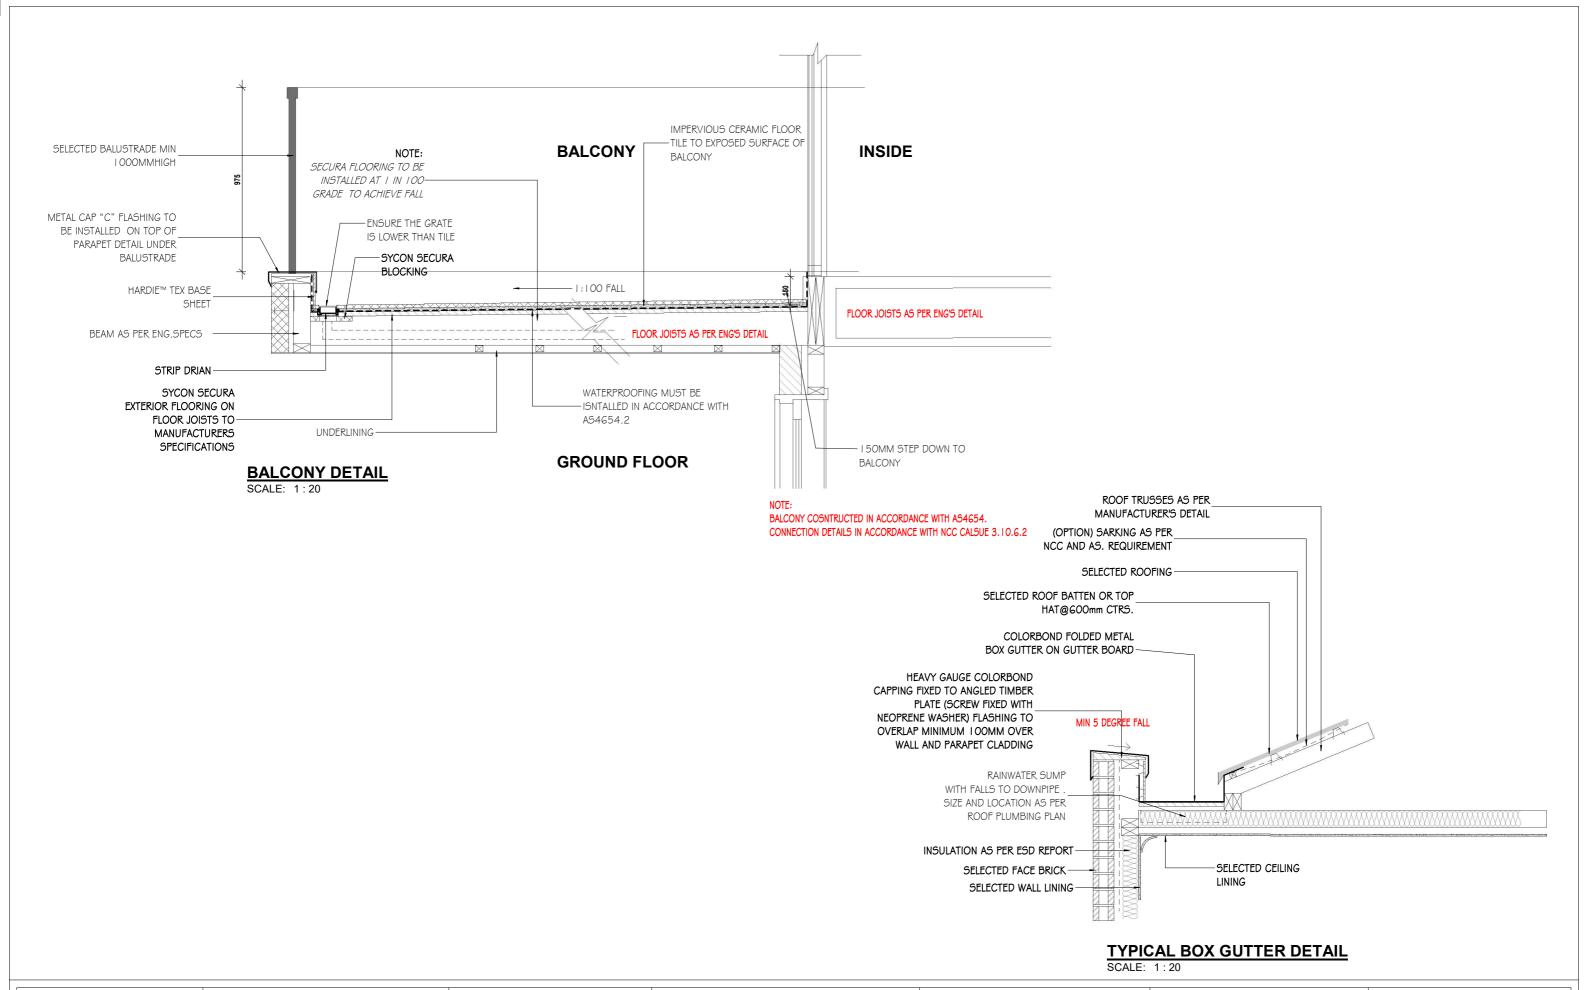



NO:	DESCRIPTION	DATE
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2	PRELIMINARY - R2	25/02/2025
3	PRELIMINARY - R3	27/02/2025
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7	FOR CONSTRUCTION	17/05/2025

CLIENT SIGN OFF: I/WE CONFIRM THAT THESE DRAWINGS ACCORD WITH OUR REQUIREMENTS AND AUTHORISE THEIR USE FOR NEXT STAGE PURPOSES.

SIGNED.. ..DATE.. SIGNED.. ..DATE..

PROPOSED NEW RESIDENCE

Lot 6507, BONNIEBROOK ROAD, BONNIEBROOK, VIC 3335 Lawrence Gilbert Makoona & Marie

Tracy Lo Shun Shing

DRAWING: **TYPICAL DETAIL**

SCALE: 1:20

JOB NUMBER: DATE: 08206 17/05/2025




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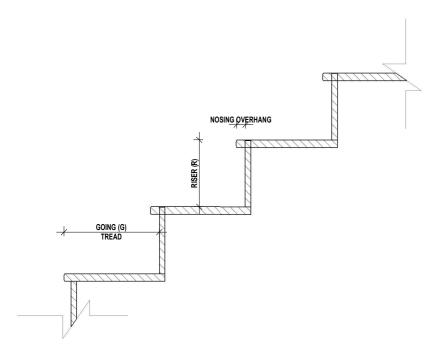
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A3002

CHECKED BY: AR DRAWN BY: RS FOR **CONSTRUCTION**



SHOWER NICHE DETAIL

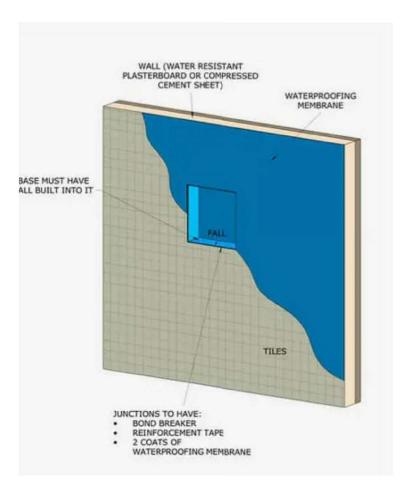

STAIR RISER / GOING DETAIL

SCALE: 1:10

STAIR CONSTRUCTION TO COMPLY WITH N.CC 2022

STAIR NOTES:

GOING (G) - 240MIN. - 355MAX. RISER (R) - 115MIN. - 190MAX. SLOPE RELATIONSHIP (2R+G) 550MIN. - 700MAX.

SLIP RESISTANCE NOTE:

TREADS MUST HAVE A SURFACE WITH A SLIP-RESISTANCE CLASSIFICATION NOT LESS THAN P3 OR R 10 IN DRY SURFACE CONDITIONS OR P4 OR RI I IN WET CONDITIONS; OR A NOSING STRIP WITH A SLIP RESISTANCE CLASSIFICATION NOT LESS THAN P3 IN DRY CONDITIONS AND P4 IN WET CONDITIONS IN ACCORDANCE WITH N.C.C. 2022 WHEN TESTED WITH AS 4586.

SELECTED HAND RAIL TO CLIENT'S SPEC. SELECTED STAIR TREADS AND DETAILS TO CLIENT'S SPECIFICATION. 250mi * TREAD SLIP RESISTANCE OF CLASS P3/R10 FOR DRY/INTERNAL OR P4/R11 FOR WET/EXTERNAL *NOSING SLIP RESISTANCE OF CLASS P3 FOR DRY/INTERNAL OR P4 FOR WET/EXTERNAL *1050MM MIN HIGH HANDRAILS *BALUSTERS AT 125mm CRS *MIN. HEAD ROOM 2050mm

TYPICAL STAIR ELEVATION DETAIL **SCALE 1:20**

STAIRCASE / BALUSTRADE NOTES

- 1. STAIRWAY CONSTRUCTION TO COMPLY WITH N.C.C 2022
- A. TREAD SIZES (OTHER THAN FOR SPIRAL STAIRS) MUST ACHIEVE À SLOPE RELATIONSHIP QUANTITY (2R+G)=700MAX. AND 550MIN.
- B. RISERS (R) TO BE 1.15MM MIN. AND 190MM MAX. AND MUST NOT ALLOW A 125MM SPHERE TO PASS THROUGH BETWEEN THE TREADS.
- C. GOINGS (G) TO BE 240MM MIN. AND 355MM MAX.
- D. EACH FLIGHT OF STAIRS MUST HAVE NO MORE THAN 18 RISERS AND NO LESS THAN 2 RISERS, STAIRS MUST NOT HAVE MORE THAN 3 WINDERS IN LIEU OF EACH QUARTER LANDING OR 6 WINDERS IN LIEU OF EACH HALF LANDING.
- 2. ALL TREADS, LANDINGS AND THE LIKE TO HAVE NON SLIP FINISH OR SUITABLE NON-SKID STRIP NEAR EDGE OF NOSING TO COMPLY WITH AS.4586 AND N.C.C 2022
- 3. LANDINGS MUST NOT BE LESS THAN 750MM LONG, BE F GUDED WHERE THE THRESHOLD SILL OF A DOORWAY OPENS ONTO STAIR THAT PROVIDES A CHANGE IN LEVEL GREATER THAN 3 RISERS OR 570MM. THE LANDING MUST EXTEND ACROSS THE FULL WIDTH OF THE DOORWAY TO COMPLY WITH N.C.C. 2022
- 4. BALUSTRADES AND HANDRAILS TO COMPLY WITH N.CC. 2022
- A. THE BALUSTRADE HEIGHT MUST NOT BE LESS THAN 865MM ABOVE THE TREAD NOSINGS AND 1000MM ABOVE ACCESS PATHS, BALCONIES, LANDINGS AND THE LIKE.
- B. OPENINGS IN BALUSTRADE OR OTHER BARRIERS MUST BE CONSTRUCTED SO THAT THEY DO NOT PERMIT A 125MM SPHERE TO PASS THROUGH IT.
- C. ANY HORIZONTAL ELEMENT WITHIN THE BALUSTRADE BETWEEN 150MM AND 760MM ABOVE THE FLOOR MUST NOT FACILITATE CLIMBING WHERE CHANGES INGLEVEL EXCEEDS 4000MM ABOVE THE SURFACE BENEATH LANDINGS, RAMPS AND/OR TREADS
- D. WIRE BALUSTRADE TO COMPLY WITH N.C.C. 2022
- E. GLASS BALUSTRADE TO COMPLY WITH AS | 288.
- 5. HEAD CLEARANCE TO STAIRS TO BE NOT LESS THAN 2000MM MEASURED VERTICALLY BETWEEN NOSING LINE AND CEILING LINE AND/OR ANY OBSTRUCTION.



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CLIENT SIGN OFF:

I/WE CONFIRM THAT THESE DRAWINGS ACCORD WITH OUR REQUIREMENTS AND AUTHORISE THEIR USE FOR NEXT STAGE PURPOSES.

SIGNED .DATE. SIGNED... ..DATE..

PROPOSED NEW RESIDENCE

Lot 6507, BONNIEBROOK ROAD, BONNIEBROOK, VIC 3335 Lawrence Gilbert Makoona & Marie Tracy Lo Shun Shing

DRAWING **TYPICAL DETAIL**

@A3

DATE:

17/05/2025

SCALE:


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DRAWING NUMBER:

A3003


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TYPICAL ENCLOSED STEPDOWN SHOWER DETAIL

TYPICAL UNENCLOSED STEPDOWN SHOWER DETAIL

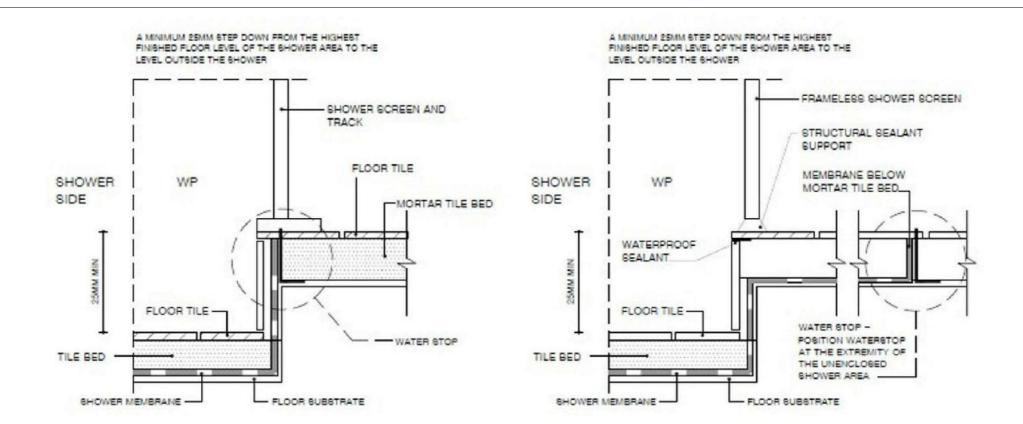

FLOOR WASTE - TYPICAL MEMBRANE TERMINATION AT DRAINAGE OUTLET

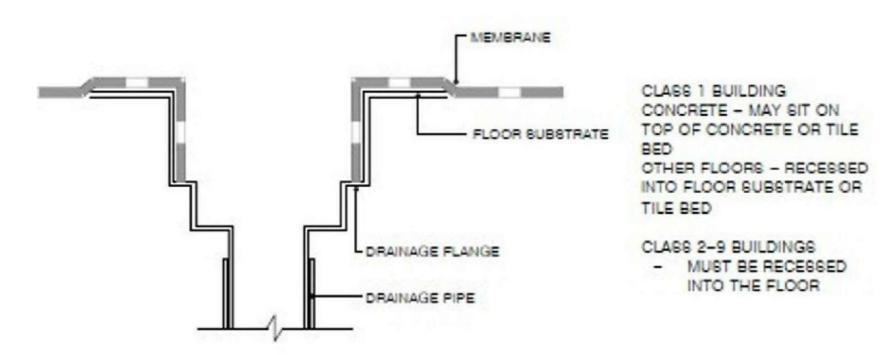

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SIGNED......DATE.....

PROPOSED NEW RESIDENCE

ADDRESS: Lot 6507, BONNIEBROOK ROAD, BONNIEBROOK, VIC 3335

ent Details: Lawrence Gilbert Makoona & Marie Tracy Lo Shun Shing

DRAWING: TYPICAL DETAIL

SCALE: 1:1

1:1 @A3 JOB NUMBER: DATE: 08206 17/05/2025




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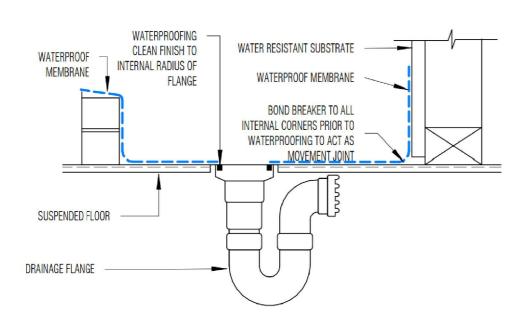





PROVIDE WATERSTOP AT THE ENTRY OF ALL WET AREAS WHERE THERE IS CONTINUOUS FLOOR TILE ON THE FLOOR PLAN AS PER AS 3740

INSTALLATION DAMP-PROOF COURSES AND FLASHING TO COMPLY WITH NCC 2022.

A) 150MM ABOVE ADJACENT GROUND LEVEL OR
(B) 75MM ABOVE THE FINISHED SURFACE LEVEL ADJACENT PAVED, CONCRETED OR LANDSCAPE ARE A THAT SLOPE AWAY FROM THE WALL OR
(C) 50MM ABOVE FINISHED PAVED, CONCRETE OR LANDSCAPED AREA COMPLYING WITH 3.1.3.3(B)(II) OF THE BCA AND PROTECTED FROM THE DIRECT EFFECTS OF THE WEATHER BY A CARPORT, VERANDAH OR THE LIKE

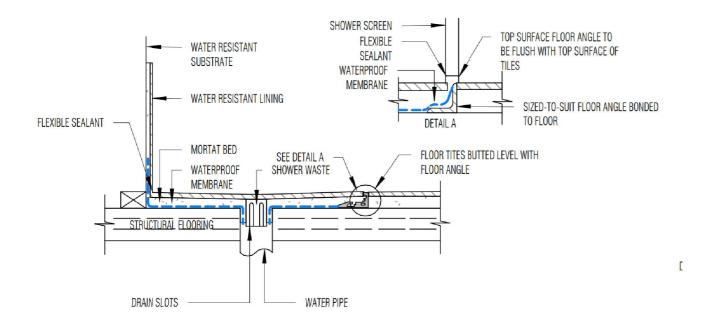

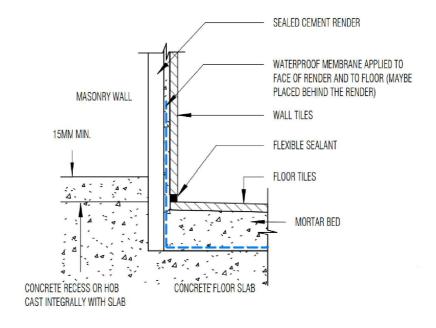

TYPICAL INSTALLATION OF WATER PROOFING MEMBRANE TO SHOWER FLOOR



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SIGNED......DATE......DATE.....

PROPOSED NEW RESIDENCE

ADDRESS:

Lot 6507, BONNIEBROOK ROAD, BONNIEBROOK, VIC 3335

Client Details: Lawrence Gilbert Makoona & Marie
Tracy Lo Shun Shing

DRAWING: TYPICAL DETAIL

SCALE:

@A3

JOB NUMBER: DATE:
08206 17/05/2025



DRAWING NUMBER:


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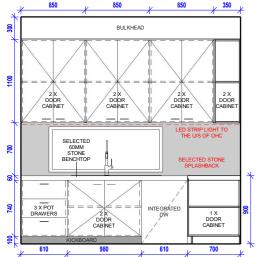
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A3005


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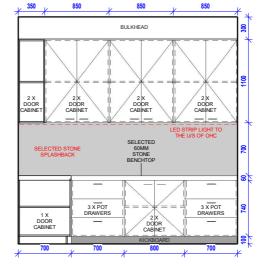





05 B'PTRY ELEVATION SCALE: 1:50

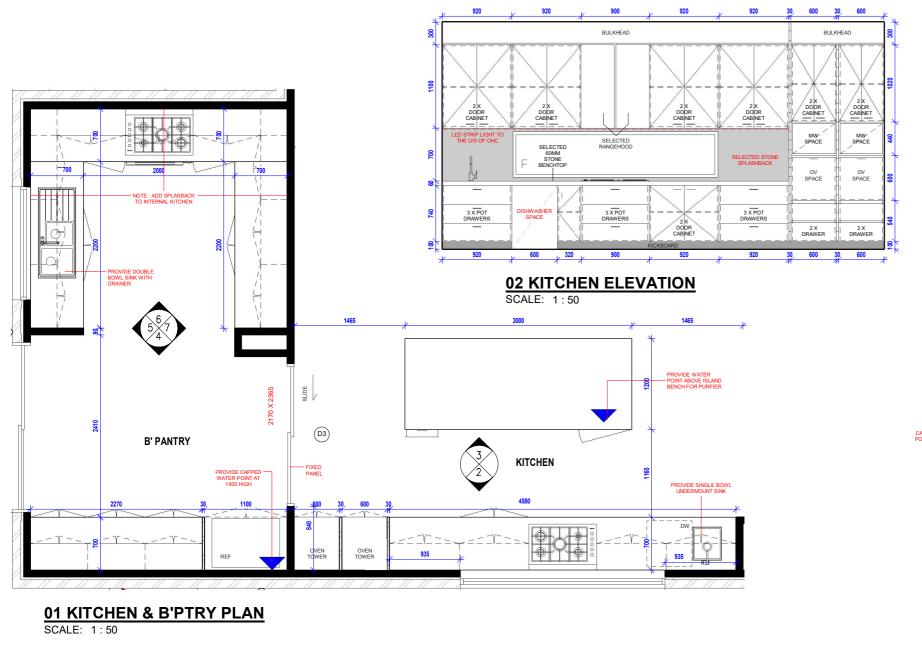

06 B'PTRY ELEVATION

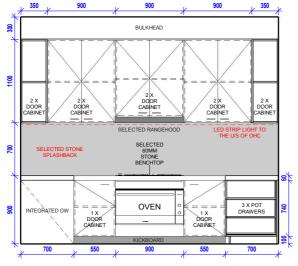


07 B'PTRY ELEVATION

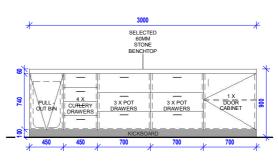


03 KITCHEN ELEVATION

SCALE: 1:50

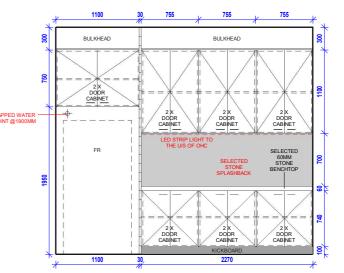

04 B'PTRY ELEVATION

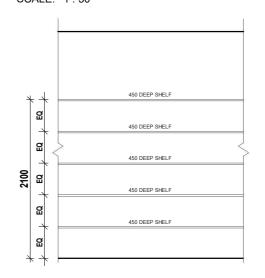

TYPICAL LINEN ELEVATION

SCALE: 1:50

NOTES / COMMENTS BY BUILDERS

INTERNAL JOINERY NOTES:

- JOINER MUST VERIFY ALL DIMENSIONS ON SITE PRIOR TO THE COMMENCEMENT OF ANY SHOP DRAWINGS, ORDERING OF MATERIALS, CONSTRUCTION OR FABRICATION WORK WHATSOEVER.

- JOINER MUST CHECK THAT SITE CONDITIONS ARE APPROPRIATE FOR INSTALLATION, INCLUDING ACCESSWAYS, DOORWAY WIDTHS ETC, PRIOR TO THE COMMENCEMENT OF ANY SHOP DRAWINGS, ORDERING OF MATERIALS, CONSTRUCTION OR FABRICATION WORK WHATSOEVER.

- JOINER MUST ALLOW TO PROVIDE CUT-OUTS AS REQUIRED FOR PIER AND DATA OUTLETS, FITTINGS AND FIXTURES.

- ALL JOINERY TO BE MANUFACTURED FROM 16mm M.D.F BOARD WITH SELECTED FINISH. PROVIDE H.M.R M.D.F BOARD IN AREAS OF MOISTURE EXPOSURE.

- ALL JOINTS MUST BE BISCUIT JOINTED OR DOWELLED, SCREWED AND GLUED UNLESS NOTED OTHERWISE.

- ALL FIXING TO BE CONCEALED UNLESS NOTED OTHERWISE.

- EXTENSIVE SUB-STRUCTURE SUPPORT TO BE PROVIDED WITH FURNITURE GRADE K.D.H.W, UNLESS NOTED OTHERWISE.

- CARPENTER / BUILDER SHALL PROVIDE ALL NECESSARY NOGGINS, STRONGBACKS, ADDITIONAL STUDS IN THE HOUSE FRAME TO SUPPORT; EQUIPMENT, JOINERY (eg. OVERHEAD CABINETS, CANTILEVERED VANITY UNITS ETC.) ALL IN ACCORDANCE WITH THE JOINERY PLANS AND REQUIREMENTS.

- ALL FIXTURE. FITTINGS. MECHANISMS. HARDWARE, HINGES AND SLIDES ETC. MUST BE INSTALLED IN ACCORDANCE WITH THE MANUFACTURER'S SPECIFICATIONS.

- FINISH WITHIN INSIDE OF CABINET CARCASS TO BE 0.4mm THICK WHITE MELAMINE.

- ADJUSTABLE SHELVES TO BE 18mm THICK WHITE MELAMINE FINISH FOR WIDTHS UP TO 1000mm. SHELVES IN CABINETS WITH GLAZED DOORS OR OPEN SHELVING, SHALL BE SELECTED FINISH. ADJUSTABLE SHELF SUPPORTS TO BE PROVIDED AT 32mm VERTICAL CENTRES.

- ALL SIZES NOTES HERE-IN ARE NIMINAL ONLY AND ARE NOT TO BE USED FOR SHOP-DRAWINGS. CABINET SIZES ARE SUBJECT TO JOINER'S CHECK MEASURE AND SHOP DRAWINGS.

- STONE BENCHTOPS TO KITCHEN, W.C. BATHROOM & ENSUITE.

- 100MM SKIRTING TILES TO WET AREAS, INCL. W.C WALLS U.N.O.

- ALL INTERNAL DIMENSIONS & ELEVATIONS DRAWN TO STUD AND MAY VARY ON SITE. CONTRACTORS TO VERIFY DIMENSIONS PRIOR TO COMMENCING ANY WORK

- ALL TILING HEIGHTS SUBJECT TO TILE SELECTION, TO BE CONFIRMED ON SITE.

- DESIGN AND THE POSITION OF DOOR AND DRAWER HANDLES IS INDICATIVE ONLY & USED TO REPRESENT HINGE-SIDE DOORS.



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CLIENT SIGN OFF: I/WE CONFIRM THAT THESE DRAWINGS ACCORD WITH OUR REQUIREMENTS AND AUTHORISE THEIR USE FOR NEXT STAGE

PURPOSES ..DATE.. ..DATE..

PROPOSED NEW RESIDENCE

Lot 6507, BONNIEBROOK ROAD, BONNIEBROOK, VIC 3335

Lawrence Gilbert Makoona & Marie Tracy Lo Shun Shing

INTERNAL ELEVATIONS

DATE:

SCALE: As indicated JOB NUMBER:

08206

DRAWING:


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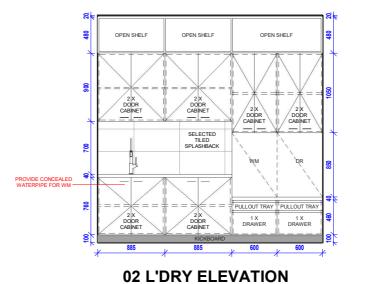
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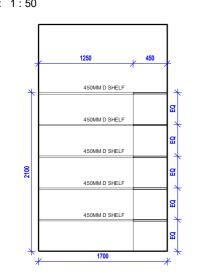
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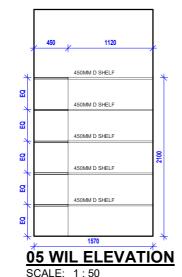








03 BRM & LINEN ELEVATION




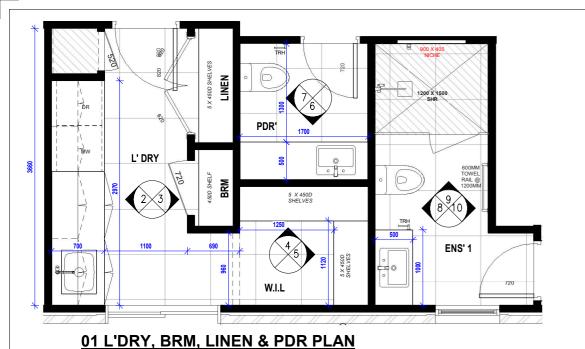


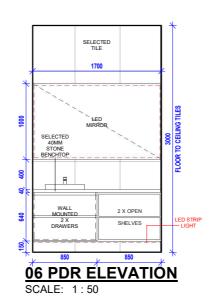


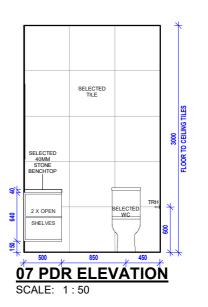

04 WIL ELEVATION

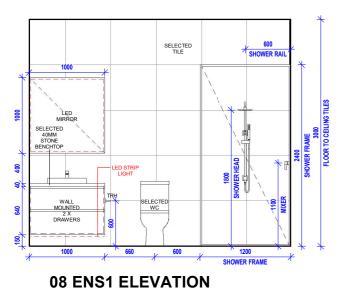

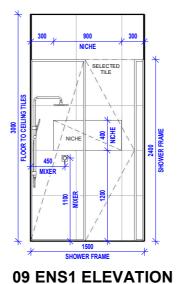

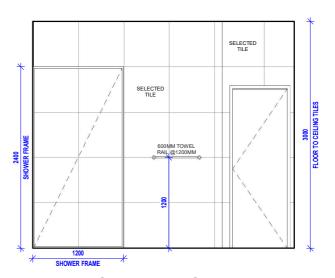

SCALE: 1:50

10 ENS1 ELEVATION

KIARA

NO:	DESCRIPTION	DATE
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7	FOR CONSTRUCTION	17/05/2025

CLIENT SIGN OFF: I/WE CONFIRM THAT THESE DRAWINGS ACCORD WITH OUR REQUIREMENTS AND AUTHORISE THEIR USE FOR NEXT STAGE PURPOSES.

..DATE.. ..DATE..

PROPOSED NEW RESIDENCE

Lot 6507, BONNIEBROOK ROAD, BONNIEBROOK, VIC 3335

Lawrence Gilbert Makoona & Marie Tracy Lo Shun Shing

DRAWING: INTERNAL ELEVATIONS

SCALE: As indicated

JOB NUMBER: DATE: 08206 17/05/2025



DRAWING NUMBER:

A8001

CHECKED BY: AR

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FOR CONSTRUCTION

NOTES / COMMENTS BY BUILDERS

- JOINER MUST VERIFY ALL DIMENSIONS ON SITE PRIOR TO THE COMMENCEMENT OF ANY SHOP

- JOINER MUST CHECK THAT SITE CONDITIONS ARE APPROPRIATE FOR INSTALLATION, INCLUDING ACCESSWAYS, DOORWAY WIDTHS ETC, PRIOR TO THE COMMENCEMENT OF ANY SHOP DRAWINGS, ORDERING OF MATERIALS, CONSTRUCTION OR FABRICATION WORK WHATSOEVER.

INTERNAL JOINERY NOTES:

DRAWINGS, ORDERING OF MATERIALS, CONSTRUCTION OR FABRICATION WORK

- JOINER MUST ALLOW TO PROVIDE CUT-OUTS AS REQUIRED FOR PIER AND DATA OUTLETS, FITTINGS AND FIXTURES.

MOISTURE EXPOSURE.

UNLESS NOTED OTHERWISE.

OTHERWISE.

OTHERWISE.

REQUIREMENTS.

- ALL JOINERY TO BE MANUFACTURED FROM 16mm M.D.F BOARD WITH SELECTED FINISH.

PROVIDE H.M.R M.D.F BOARD IN AREAS OF

- ALL JOINTS MUST BE BISCUIT JOINTED OR DOWELLED, SCREWED AND GLUED UNLESS NOTED

- ALL FIXING TO BE CONCEALED UNLESS NOTED

- EXTENSIVE SUB-STRUCTURE SUPPORT TO BE PROVIDED WITH FURNITURE GRADE K.D.H.W,

- CARPENTER / BUILDER SHALL PROVIDE ALL NECESSARY NOGGINS, STRONGBACKS, ADDITIONAL STUDS IN THE HOUSE FRAME TO SUPPORT; EQUIPMENT, JOINERY (eg. OVERHEAD CABINETS, CANTILEVERED VANITY UNITS ETC.) ALL IN ACCORDANCE WITH THE JOINERY PLANS AND

- ALL FIXTURE, FITTINGS, MECHANISMS.

MANUFACTURER'S SPECIFICATIONS.

BE 0.4mm THICK WHITE MELAMINE

32mm VERTICAL CENTRES.

BATHROOM & ENSUITE.

COMMENCING ANY WORK

TO BE CONFIRMED ON SITE.

WALLS U.N.O.

MEASURE AND SHOP DRAWINGS. - STONE BENCHTOPS TO KITCHEN, W.C.

HARDWARE, HINGES AND SLIDES ETC. MUST BE INSTALLED IN ACCORDANCE WITH THE

- FINISH WITHIN INSIDE OF CABINET CARCASS TO

- ADJUSTABLE SHELVES TO BE 18mm THICK WHITE MELAMINE FINISH FOR WIDTHS UP TO 1000mm. SHELVES IN CABINETS WITH GLAZED DOORS OR OPEN SHELVING. SHALL BE SELECTED FINISH. ADJUSTABLE SHELF SUPPORTS TO BE PROVIDED AT

- ALL SIZES NOTES HERE-IN ARE NIMINAL ONLY AND ARE NOT TO BE USED FOR SHOP-DRAWINGS. CABINET SIZES ARE SUBJECT TO JOINER'S CHECK

- 100MM SKIRTING TILES TO WET AREAS, INCL. W.C

- ALL TILING HEIGHTS SUBJECT TO TILE SELECTION,


- DESIGN AND THE POSITION OF DOOR AND

DRAWER HANDLES IS INDICATIVE ONLY & USED TO REPRESENT HINGE-SIDE DOORS.

- ALL INTERNAL DIMENSIONS & ELEVATIONS DRAWN TO STUD AND MAY VARY ON SITE. CONTRACTORS TO VERIFY DIMENSIONS PRIOR TO

WHATSOEVER.

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NOTES / COMMENTS BY BUILDERS
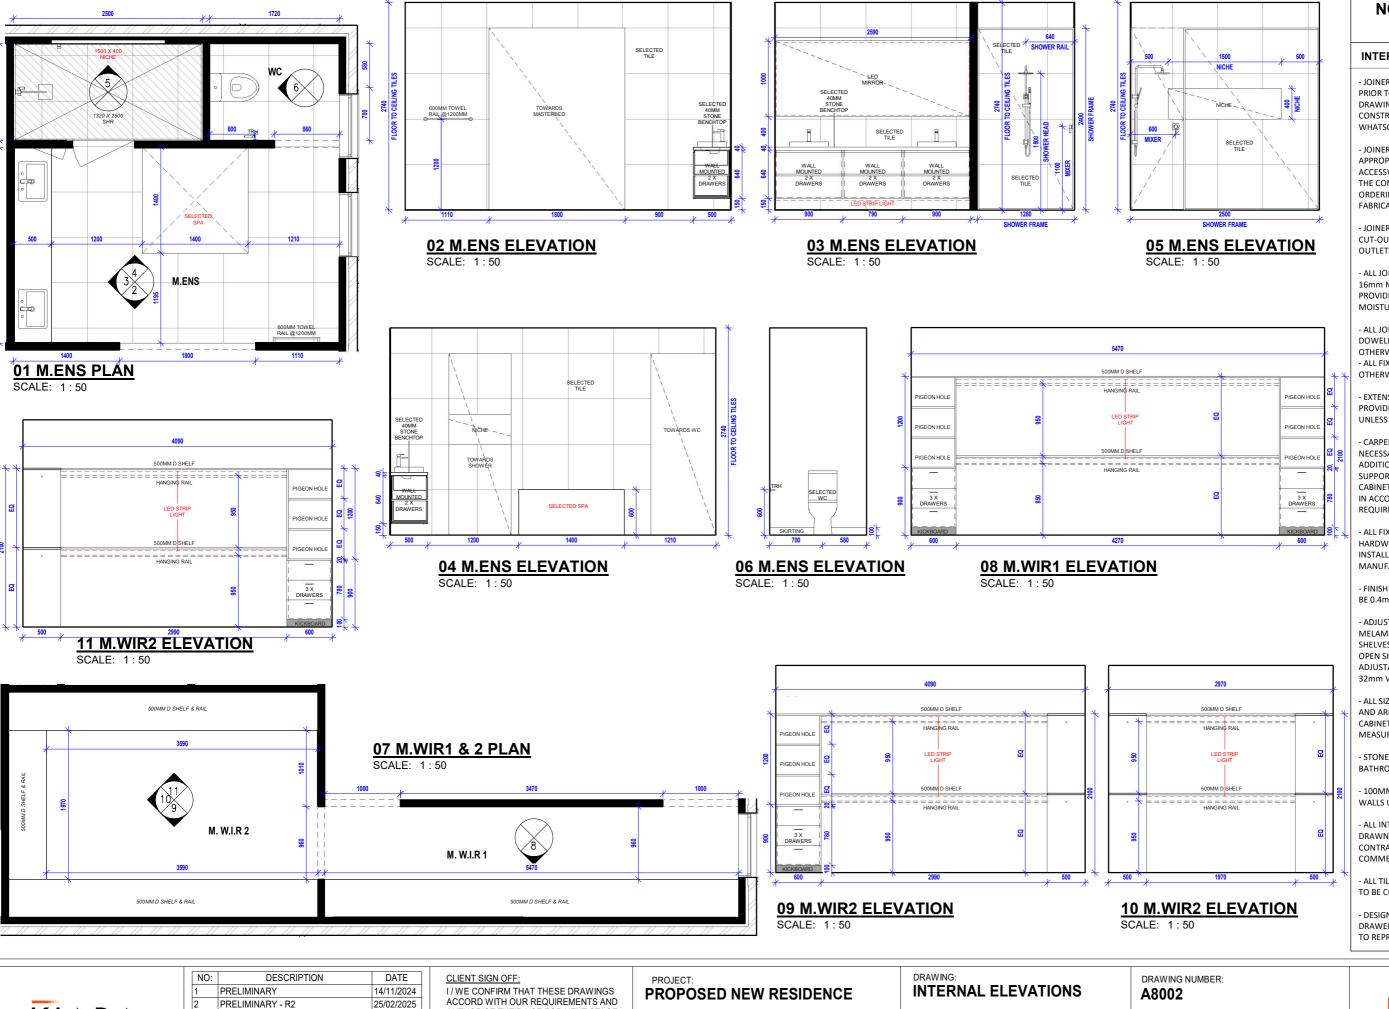
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- ALL JOINERY TO BE MANUFACTURED FROM 16mm M.D.F BOARD WITH SELECTED FINISH. PROVIDE H.M.R M.D.F BOARD IN AREAS OF MOISTURE EXPOSURE.
- ALL JOINTS MUST BE BISCUIT JOINTED OR DOWELLED, SCREWED AND GLUED UNLESS NOTED OTHERWISE.
- ALL FIXING TO BE CONCEALED UNLESS NOTED OTHERWISE.
- EXTENSIVE SUB-STRUCTURE SUPPORT TO BE PROVIDED WITH FURNITURE GRADE K.D.H.W, UNLESS NOTED OTHERWISE.
- CARPENTER / BUILDER SHALL PROVIDE ALL NECESSARY NOGGINS, STRONGBACKS, ADDITIONAL STUDS IN THE HOUSE FRAME TO SUPPORT; EQUIPMENT, JOINERY (eg. OVERHEAD CABINETS, CANTILEVERED VANITY UNITS ETC.) ALL IN ACCORDANCE WITH THE JOINERY PLANS AND REQUIREMENTS.
- ALL FIXTURE FITTINGS MECHANISMS HARDWARE, HINGES AND SLIDES ETC. MUST BE INSTALLED IN ACCORDANCE WITH THE MANUFACTURER'S SPECIFICATIONS.
- FINISH WITHIN INSIDE OF CABINET CARCASS TO BE 0.4mm THICK WHITE MELAMINE.
- ADJUSTABLE SHELVES TO BE 18mm THICK WHITE MELAMINE FINISH FOR WIDTHS UP TO 1000mm. SHELVES IN CABINETS WITH GLAZED DOORS OR OPEN SHELVING. SHALL BE SELECTED FINISH. ADJUSTABLE SHELF SUPPORTS TO BE PROVIDED AT 32mm VERTICAL CENTRES.
- ALL SIZES NOTES HERE-IN ARE NIMINAL ONLY AND ARE NOT TO BE USED FOR SHOP-DRAWINGS. CABINET SIZES ARE SUBJECT TO JOINER'S CHECK MEASURE AND SHOP DRAWINGS.
- STONE BENCHTOPS TO KITCHEN, W.C. BATHROOM & ENSUITE
- 100MM SKIRTING TILES TO WET AREAS, INCL. W.C WALLS U.N.O.
- ALL INTERNAL DIMENSIONS & ELEVATIONS DRAWN TO STUD AND MAY VARY ON SITE. CONTRACTORS TO VERIFY DIMENSIONS PRIOR TO COMMENCING ANY WORK.
- ALL TILING HEIGHTS SUBJECT TO TILE SELECTION, TO BE CONFIRMED ON SITE.
- DESIGN AND THE POSITION OF DOOR AND DRAWER HANDLES IS INDICATIVE ONLY & USED TO REPRESENT HINGE-SIDE DOORS.



NO:	DESCRIPTION	DATE
1	PRELIMINARY	14/11/2024
2	PRELIMINARY - R2	25/02/2025
3	PRELIMINARY - R3	27/02/2025
4	DEVELOPER APPROVAL	28/03/2025
5	DEVELOPER APPROVAL - R2	21/04/2025
6	DEVELOPER APPROVAL - R3	02/05/2025
7	FOR CONSTRUCTION	17/05/2025

AUTHORISE THEIR USE FOR NEXT STAGE PURPOSES.

..DATE. ..DATE..

Lot 6507, BONNIEBROOK ROAD, BONNIEBROOK, VIC 3335 Lawrence Gilbert Makoona & Marie

Tracy Lo Shun Shing


SCALE: As indicated

JOB NUMBER: DATE: 08206 17/05/2025





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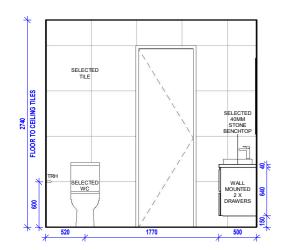
SELECTED TILF **02 BATH ELEVATION**



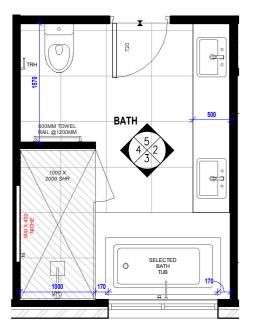

04 BATH ELEVATION

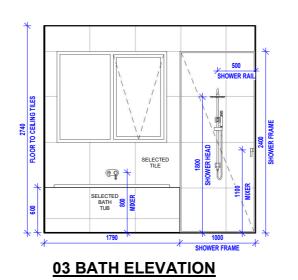01 BATH PLAN

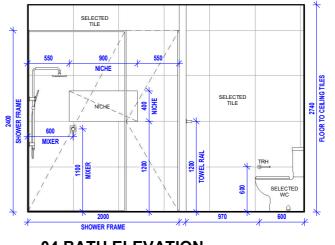



05 BATH ELEVATION

ENS' 5

06 ENS5 PLAN

SCALE: 1:50

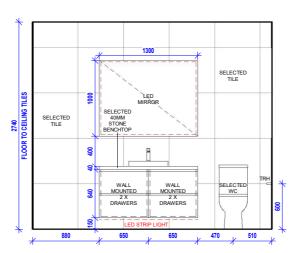


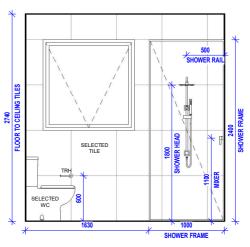



07 ENS5 ELEVATION

08 ENS5 ELEVATION

SELECTED TILE

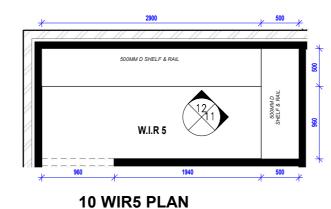

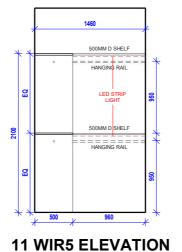

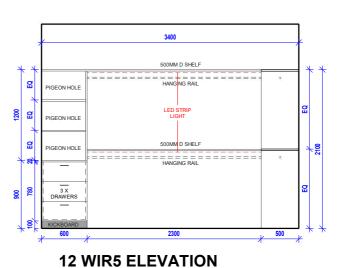

KIARA

09 ENS5 ELEVATION

NO:	DESCRIPTION	DATE
1	PRELIMINARY	14/11/2024
2	PRELIMINARY - R2	25/02/2025
3	PRELIMINARY - R3	27/02/2025
4	DEVELOPER APPROVAL	28/03/2025
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6	DEVELOPER APPROVAL - R3	02/05/2025
7	FOR CONSTRUCTION	17/05/2025

CLIENT SIGN OFF: I/WE CONFIRM THAT THESE DRAWINGS ACCORD WITH OUR REQUIREMENTS AND AUTHORISE THEIR USE FOR NEXT STAGE

PURPOSES. ..DATE. SIGNED... ..DATE..

PROPOSED NEW RESIDENCE

Lot 6507, BONNIEBROOK ROAD, BONNIEBROOK, VIC 3335 Lawrence Gilbert Makoona & Marie Tracy Lo Shun Shing

SCALE: 1:50

INTERNAL ELEVATIONS

DRAWING:

DATE: 17/05/2025

SCALE: 1:50

DRAWING NUMBER:

A8003



NOTES / COMMENTS BY BUILDERS

- JOINER MUST VERIFY ALL DIMENSIONS ON SITE PRIOR TO THE COMMENCEMENT OF ANY SHOP DRAWINGS, ORDERING OF MATERIALS,

- JOINER MUST CHECK THAT SITE CONDITIONS ARE APPROPRIATE FOR INSTALLATION, INCLUDING ACCESSWAYS, DOORWAY WIDTHS ETC, PRIOR TO THE COMMENCEMENT OF ANY SHOP DRAWINGS, ORDERING OF MATERIALS, CONSTRUCTION OR FABRICATION WORK WHATSOEVER. JOINER MUST ALLOW TO PROVIDE CUT-OUTS AS REQUIRED FOR PIER AND DATA

INTERNAL JOINERY NOTES:

CONSTRUCTION OR FABRICATION WORK

OUTLETS, FITTINGS AND FIXTURES.

MOISTURE EXPOSURE

UNLESS NOTED OTHERWISE.

OTHERWISE.

OTHERWISE.

REQUIREMENTS.

- ALL JOINERY TO BE MANUFACTURED FROM 16mm M.D.F BOARD WITH SELECTED FINISH.

PROVIDE H.M.R M.D.F BOARD IN AREAS OF

- ALL JOINTS MUST BE BISCUIT JOINTED OR

DOWELLED, SCREWED AND GLUED UNLESS NOTED

- ALL FIXING TO BE CONCEALED UNLESS NOTED

- EXTENSIVE SUB-STRUCTURE SUPPORT TO BE PROVIDED WITH FURNITURE GRADE K.D.H.W,

- CARPENTER / BUILDER SHALL PROVIDE ALL

NECESSARY NOGGINS, STRONGBACKS, ADDITIONAL STUDS IN THE HOUSE FRAME TO SUPPORT; EQUIPMENT, JOINERY (eg. OVERHEAD CABINETS, CANTILEVERED VANITY UNITS ETC.) ALL

IN ACCORDANCE WITH THE JOINERY PLANS AND

- FINISH WITHIN INSIDE OF CABINET CARCASS TO

- ADJUSTABLE SHELVES TO BE 18mm THICK WHITE

MELAMINE FINISH FOR WIDTHS UP TO 1000mm. SHELVES IN CABINETS WITH GLAZED DOORS OR

- ALL SIZES NOTES HERE-IN ARE NIMINAL ONLY

AND ARE NOT TO BE USED FOR SHOP-DRAWINGS. CABINET SIZES ARE SUBJECT TO JOINER'S CHECK

- 100MM SKIRTING TILES TO WET AREAS, INCL. W.C

- ALL TILING HEIGHTS SUBJECT TO TILE SELECTION,

- DESIGN AND THE POSITION OF DOOR AND

DRAWER HANDLES IS INDICATIVE ONLY & USED TO REPRESENT HINGE-SIDE DOORS.

- ALL INTERNAL DIMENSIONS & ELEVATIONS DRAWN TO STUD AND MAY VARY ON SITE. CONTRACTORS TO VERIFY DIMENSIONS PRIOR TO

OPEN SHELVING. SHALL BE SELECTED FINISH. ADJUSTABLE SHELF SUPPORTS TO BE PROVIDED AT

- ALL FIXTURE, FITTINGS, MECHANISMS, HARDWARE, HINGES AND SLIDES ETC. MUST BE INSTALLED IN ACCORDANCE WITH THE

MANUFACTURER'S SPECIFICATIONS.

BE 0.4mm THICK WHITE MELAMINE.

32mm VERTICAL CENTRES.

BATHROOM & ENSUITE.

COMMENCING ANY WORK.

TO BE CONFIRMED ON SITE

WALLS U.N.O.


MEASURE AND SHOP DRAWINGS.


- STONE BENCHTOPS TO KITCHEN, W.C.


WHATSOEVER.


SCALE: As indicated JOB NUMBER: 08206

CHECKED BY: AR DRAWN BY: RS © COPYRIGHT 2020 Kiara Designs ALL RIGHTS RESERVED

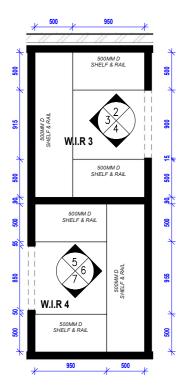

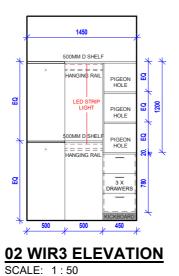


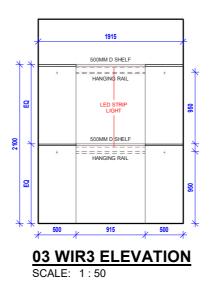


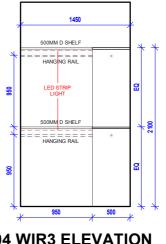



04 WIR3 ELEVATION

01 WIR3 & 4 PLAN

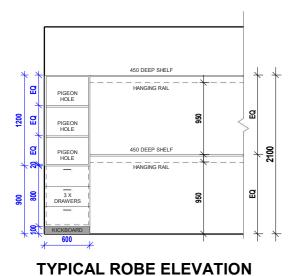

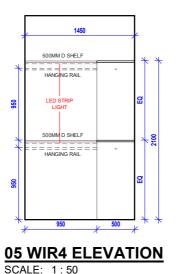

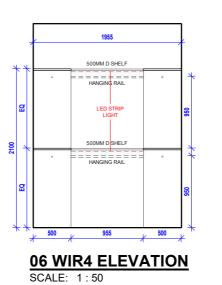

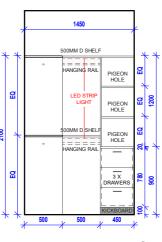

07 WIR4 ELEVATION

SCALE: 1:50

KIARA

NO:	DESCRIPTION	DATE
1	PRELIMINARY	14/11/2024
2	PRELIMINARY - R2	25/02/2025
3	PRELIMINARY - R3	27/02/2025
4	DEVELOPER APPROVAL	28/03/2025
5	DEVELOPER APPROVAL - R2	21/04/2025
6	DEVELOPER APPROVAL - R3	02/05/2025
7	FOR CONSTRUCTION	17/05/2025

CLIENT SIGN OFF: I/WE CONFIRM THAT THESE DRAWINGS ACCORD WITH OUR REQUIREMENTS AND AUTHORISE THEIR USE FOR NEXT STAGE PURPOSES.

..DATE.. ..DATE..

PROPOSED NEW RESIDENCE

Lot 6507, BONNIEBROOK ROAD, BONNIEBROOK, VIC 3335

Lawrence Gilbert Makoona & Marie Tracy Lo Shun Shing

DRAWING: INTERNAL ELEVATIONS

SCALE: As indicated

JOB NUMBER: DATE: 08206 17/05/2025



DRAWING NUMBER:

A8004

CHECKED BY: AR DRAWN BY: RS

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NOTES / COMMENTS BY BUILDERS

- JOINER MUST VERIFY ALL DIMENSIONS ON SITE PRIOR TO THE COMMENCEMENT OF ANY SHOP DRAWINGS, ORDERING OF MATERIALS, CONSTRUCTION OR FABRICATION WORK

- JOINER MUST CHECK THAT SITE CONDITIONS ARE APPROPRIATE FOR INSTALLATION, INCLUDING ACCESSWAYS, DOORWAY WIDTHS ETC, PRIOR TO THE COMMENCEMENT OF ANY SHOP DRAWINGS, ORDERING OF MATERIALS, CONSTRUCTION OR FABRICATION WORK WHATSOEVER. - JOINER MUST ALLOW TO PROVIDE CUT-OUTS AS REQUIRED FOR PIER AND DATA OUTLETS, FITTINGS AND FIXTURES.

- ALL JOINERY TO BE MANUFACTURED FROM 16mm M.D.F BOARD WITH SELECTED FINISH. PROVIDE H.M.R M.D.F BOARD IN AREAS OF

- ALL JOINTS MUST BE BISCUIT JOINTED OR DOWELLED, SCREWED AND GLUED UNLESS NOTED

- ALL FIXING TO BE CONCEALED UNLESS NOTED

- EXTENSIVE SUB-STRUCTURE SUPPORT TO BE PROVIDED WITH FURNITURE GRADE K.D.H.W.

- CARPENTER / BUILDER SHALL PROVIDE ALL

NECESSARY NOGGINS, STRONGBACKS, ADDITIONAL STUDS IN THE HOUSE FRAME TO SUPPORT; EQUIPMENT, JOINERY (eg. OVERHEAD CABINETS, CANTILEVERED VANITY UNITS ETC.) ALL IN ACCORDANCE WITH THE JOINERY PLANS AND

- ALL FIXTURE, FITTINGS, MECHANISMS, HARDWARE, HINGES AND SLIDES ETC. MUST BE INSTALLED IN ACCORDANCE WITH THE

- FINISH WITHIN INSIDE OF CABINET CARCASS TO

- ADJUSTABLE SHELVES TO BE 18mm THICK WHITE MELAMINE FINISH FOR WIDTHS UP TO 1000mm. SHELVES IN CABINETS WITH GLAZED DOORS OR OPEN SHELVING, SHALL BE SELECTED FINISH. ADJUSTABLE SHELF SUPPORTS TO BE PROVIDED AT

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- 100MM SKIRTING TILES TO WET AREAS, INCL. W.C

- ALL INTERNAL DIMENSIONS & ELEVATIONS DRAWN TO STUD AND MAY VARY ON SITE. CONTRACTORS TO VERIFY DIMENSIONS PRIOR TO

- ALL TILING HEIGHTS SUBJECT TO TILE SELECTION,

- DESIGN AND THE POSITION OF DOOR AND DRAWER HANDLES IS INDICATIVE ONLY & USED TO REPRESENT HINGE-SIDE DOORS.

MANUFACTURER'S SPECIFICATIONS.

BE 0.4mm THICK WHITE MELAMINE.

32mm VERTICAL CENTRES.

BATHROOM & ENSUITE.

COMMENCING ANY WORK

TO BE CONFIRMED ON SITE.

WALLS U.N.O.

MEASURE AND SHOP DRAWINGS. - STONE BENCHTOPS TO KITCHEN, W.C,

INTERNAL JOINERY NOTES:

WHATSOEVER.


MOISTURE EXPOSURE.


UNLESS NOTED OTHERWISE.

OTHERWISE.

OTHERWISE.

REQUIREMENTS.

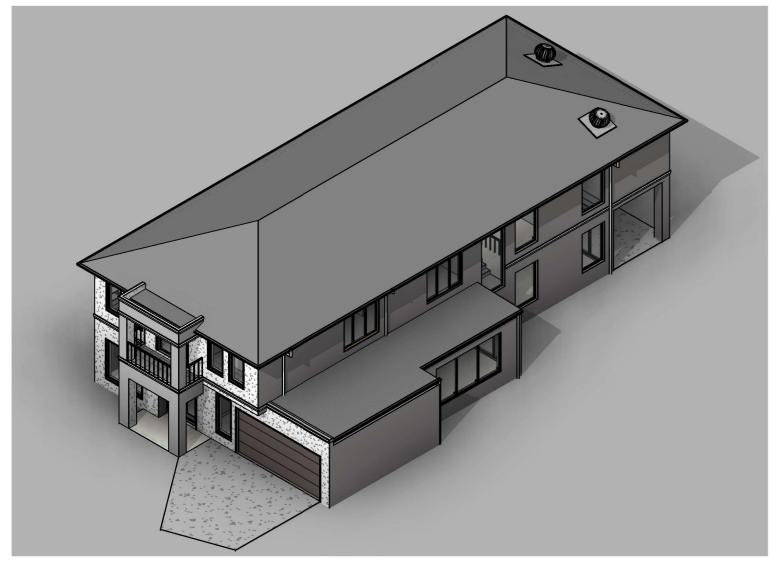

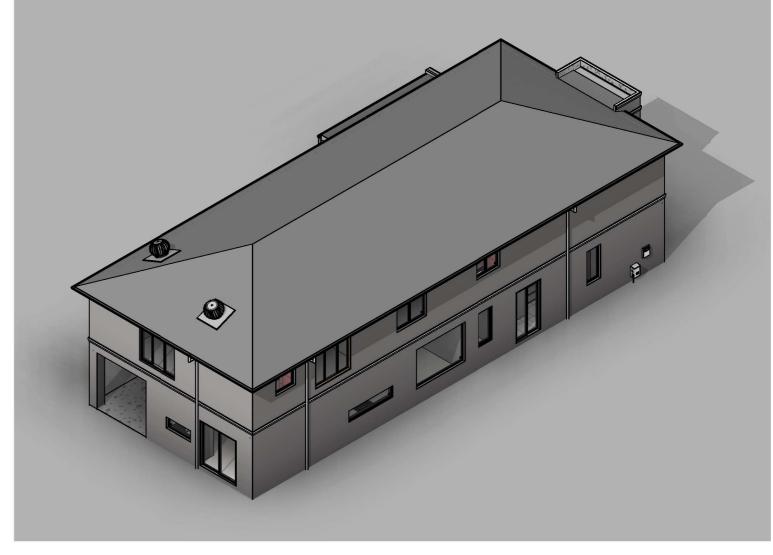

NORTH-EAST ELEVATION SCALE:

SCALE:



NO:	DESCRIPTION	DATE
1	PRELIMINARY	14/11/2024
2	PRELIMINARY - R2	25/02/2025
3	PRELIMINARY - R3	27/02/2025
4	DEVELOPER APPROVAL	28/03/2025
5	DEVELOPER APPROVAL - R2	21/04/2025
6	DEVELOPER APPROVAL - R3	02/05/2025
7	FOR CONSTRUCTION	17/05/2025

CLIENT SIGN OFF:

1/WE CONFIRM THAT THESE DRAWINGS
ACCORD WITH OUR REQUIREMENTS AND
AUTHORISE THEIR USE FOR NEXT STAGE
PURPOSES.

SIGNED...

PROPOSED NEW RESIDENCE

Lot 6507, BONNIEBROOK ROAD, BONNIEBROOK, VIC 3335 Lawrence Gilbert Makoona & Marie Tracy Lo Shun Shing

DRAWING: 3D ELEVATIONS

SCALE:


JOB NUMBER: DATE: 08206 17/05/2025




DRAWING NUMBER: A9000

DRAWN BY: RS CHECKED BY: AR



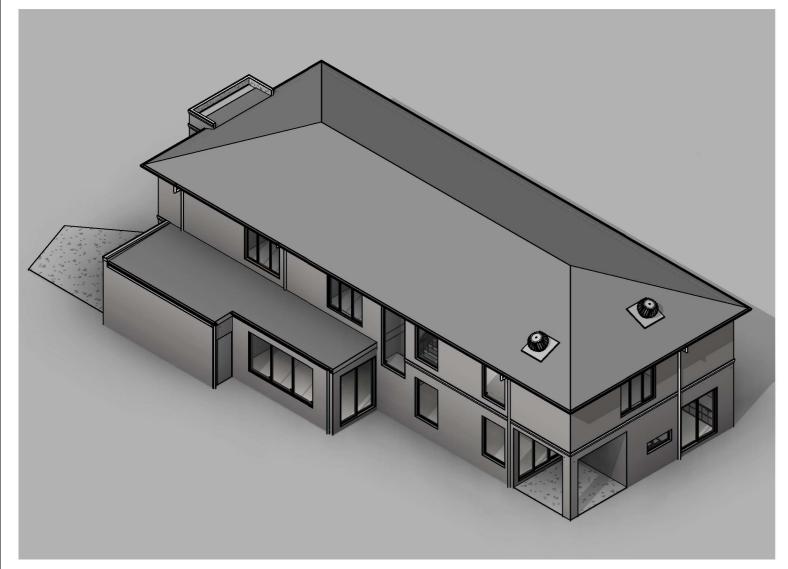

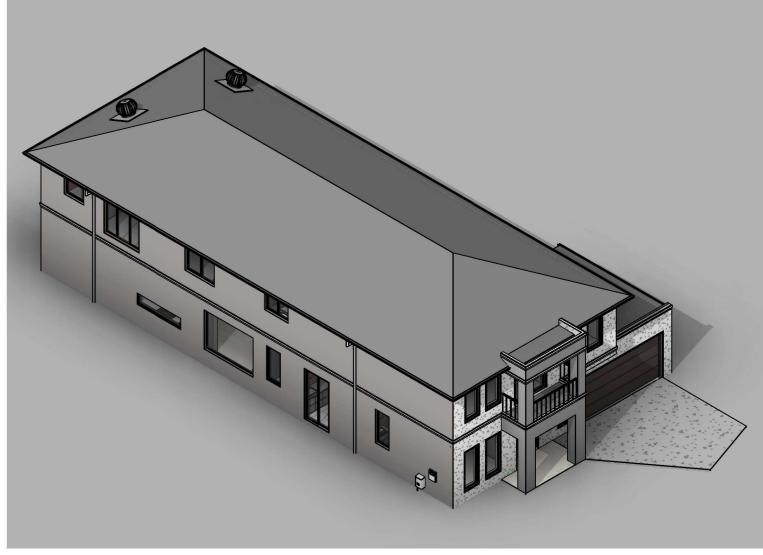

NORTH-WEST ELEVATION SCALE:

SOUTH-EAST ELEVATION SCALE:



DESCRIPTION	DATE
PRELIMINARY	14/11/2024
PRELIMINARY - R2	25/02/2025
PRELIMINARY - R3	27/02/2025
DEVELOPER APPROVAL	28/03/2025
DEVELOPER APPROVAL - R2	21/04/2025
DEVELOPER APPROVAL - R3	02/05/2025
FOR CONSTRUCTION	17/05/2025
	PRELIMINARY PRELIMINARY - R2 PRELIMINARY - R3 DEVELOPER APPROVAL DEVELOPER APPROVAL - R2 DEVELOPER APPROVAL - R3

CLIENT SIGN OFF:

1/WE CONFIRM THAT THESE DRAWINGS
ACCORD WITH OUR REQUIREMENTS AND
AUTHORISE THEIR USE FOR NEXT STAGE
PURPOSES.

SIGNED...

PROPOSED NEW RESIDENCE

Lot 6507, BONNIEBROOK ROAD, BONNIEBROOK, VIC 3335

Lawrence Gilbert Makoona & Marie Tracy Lo Shun Shing

DRAWING: 3D ELEVATIONS

DATE:

SCALE:

JOB NUMBER: 08206



DRAWING NUMBER: A9001

CHECKED BY: AR

DRAWN BY: RS

